# LAHC, Seniors living Development (x8 Units) 15-17 Combles Pde & 2-4 Hamel Rd, Matraville, NSW Part 5 Issue

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**Civil Drawing Schedule** 

| 210280 | C01  | Notes & Le  |
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| 210280 | C02  | Ground Flo  |
| 210280 | C03  | Road Front  |
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| 210280 | C10  | Turning Pa  |
| 210280 | C11  | Turning Pa  |
| 210280 | C12  | Turning Pa  |
| 210280 | C14  | Turning Pat |
| 210280 | ESM1 | Notes & Le  |
| 210280 | ESM2 | Environme   |
|        |      |             |



# Lots 34 & 36, DP 36250 Wednesday, 25th October 2023

Legends Floor Drainage Plan Intage Plan Inwater Details Sheet 1 Paths Sheet 1 Paths Sheet 2 Paths Sheet 3 Paths Sheet 4 Legends nental Site Management Plan Landscape Drawing Schedule

2701.21 2701.21 L01 L02 Landscape Plan Landscape Details

Survey Drawing Schedule 5949-DET1\_B 1 5949-DET1\_B 2



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# Survey Plan Showing Details & Levels Survey Plan Showing Details & Levels







# LAHC

Seniors living Development (x8 Units) 15-17 Combles Pde & 2-4 Hamel Rd, Matraville, NSW Drawn; CP Checked; AT Plot date; 23/10/25 Scale; as noted @ AI


Project No; 2701.21

LAHC Project No; BGXPR

Drawing No; DA00

Revision#; DA2

Cover Sheet & Location Plan

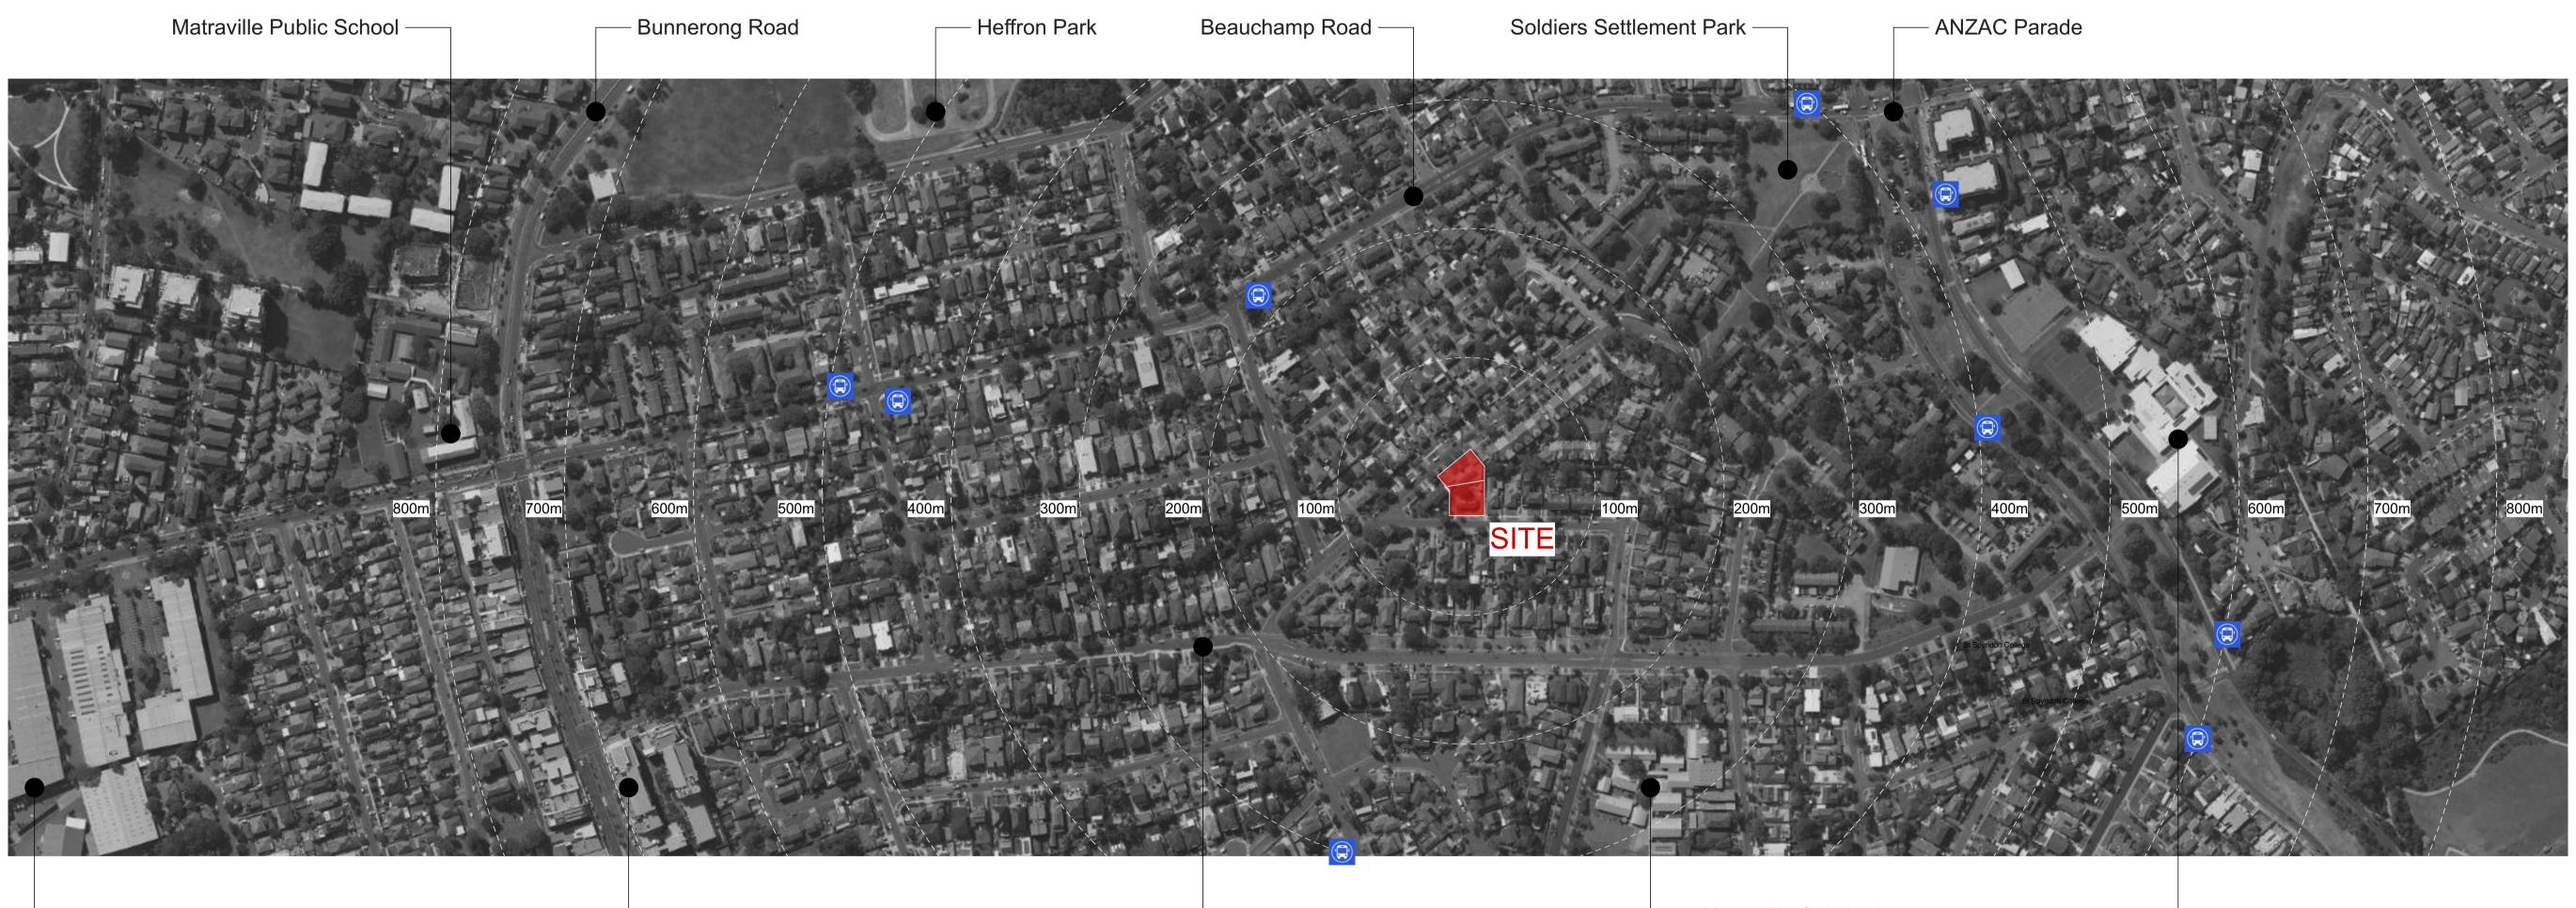

- Industrial/commercial area

- Woolworth

- Pozieres Ave

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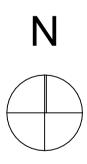
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|      |                    |          |



0008956900 28 Sep 2023







# LAHC

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Scale;1:1, 1:14.094 as noted @ AI

Project No; 2701.21

Drawing No;

DA01


LAHC Project No; BGXPR

Revision#; DA2

Location Analysis

- St Spyridon College

Legend: H h Hhigh retention valueMmedium retention value

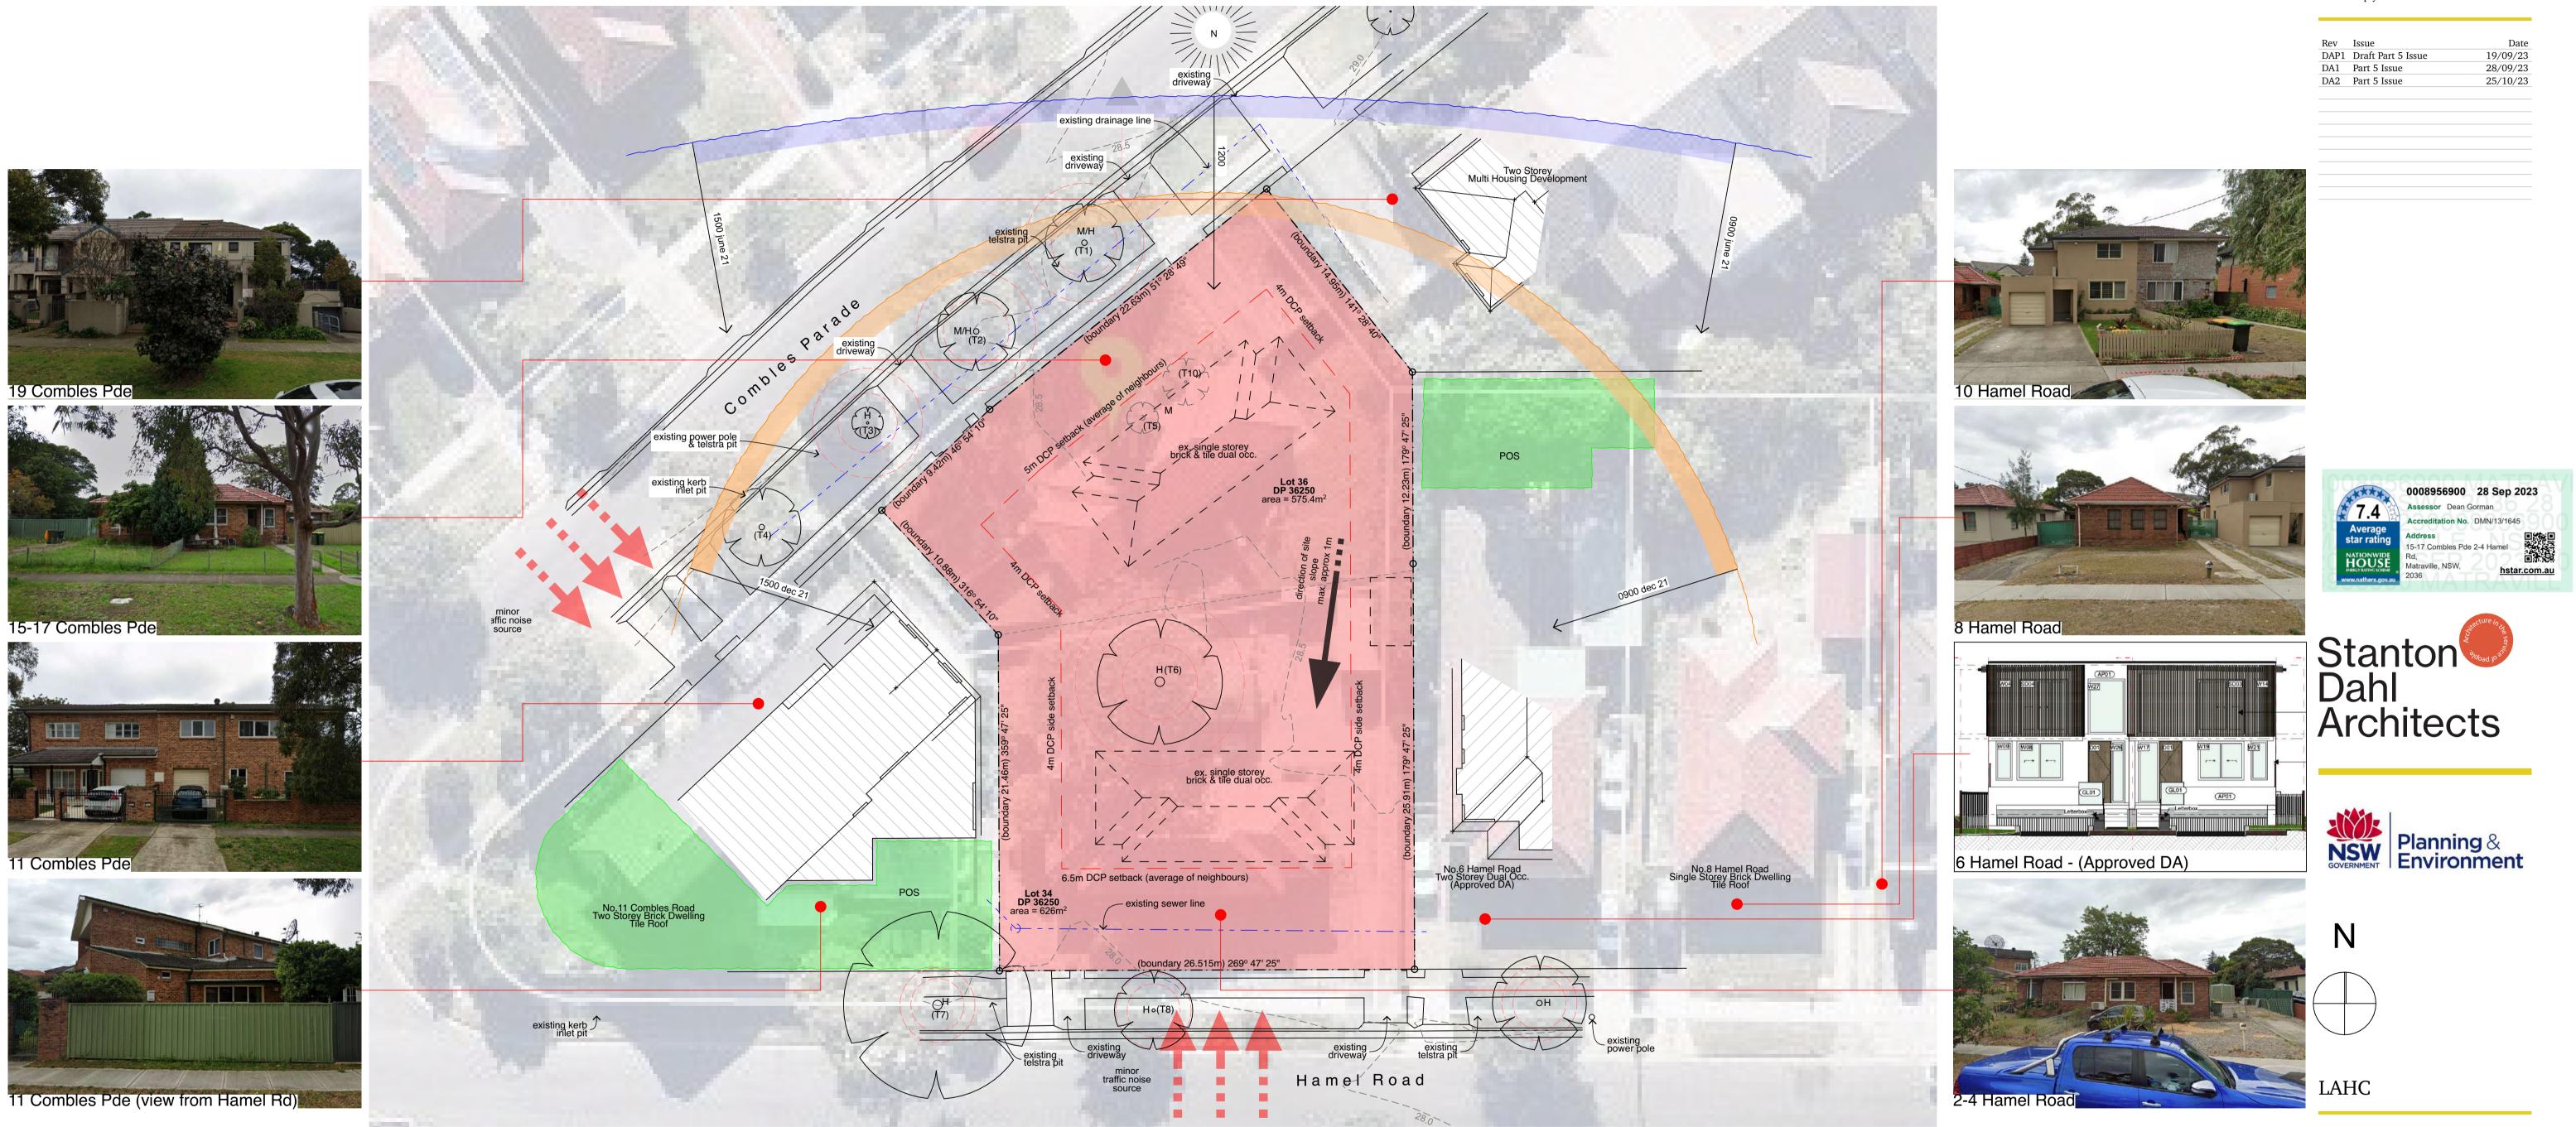

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Seniors living Development (x8 Units) 15-17 Combles Pde & 2-4 Hamel Rd, Matraville, NSW

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Project No; 2701.21

LAHC Project No; BGXPR

Drawing No; DA02

Revision#; DA2

Site Analysis

# Recent Developments in the area



No. 60 Pozieres Avenue



No. 3 Bapaume Parade





No. 38 Pozieres Avenue




No. 25 Menin Road



No. 32 Combles Parade

note: setbacks are based on available information such as google maps

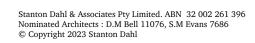

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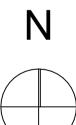
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# LAHC

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Project No; 2701.21

LAHC Project No; BGXPR

Drawing No; DA03

Revision#; DA2

Character Analysis

|                        |   | DEVELC   | OPMENT D   | )ATA – Sen   | iors Housin  | g  |  |
|------------------------|---|--|--|--|--|--|--|
|                        |   |  | ARY CONTROLS   |  |  |  | checklist but rather a                               |
|                        |   |  | lards contained  |  | & LAHC Dwelling  |  | and compliance with all<br>vill be required to be    |
| JOB<br>REFERENCE       |   |  |  | BGX  | PR   |  |  |
| LOCALITY /<br>SUBURB   |   |  |  | Matra  | ville  |  |  |
| STREET                 |   |  | 1  | 5-17 Combles Pde   | & 2-4 Hamel Rd,  |  |  |
| LOT<br>NUMBER(S)       |   |  | Lo   | nts 34 & 36 in Dep   | osited Plan 36250  |  |  |
| & DP                   |   |  |  |  |  |  |  |
| SITE AREA<br>(sqm)     |   |  |  | 01.4m <sup>2</sup> – sourced<br>1205.6 m <sup>2</sup> – sourc                                      | from Deposit Plan<br>ced from Survey   | 1  |  |
| NUMBER OF<br>EXISTING  |   |  |  | 2 (34 8  | & 36)  |  |  |
| LOTS<br>LGA            |   |  |  | Pandwick Ci  | tu Council   |  |  |
| ZONING                 |   |  |  | Randwick Ci  |  |  |  |
| ACCESSIBLE             |   |  |  | R2 - Low Density F   | Residential Zone   |  |  |
| AREA                   |   |  |  |  |  |  |  |
|                        |   |  | Internal Area<br>(m²)  |  | Private c  | ppen Space                                 |  |
|                        | Number  | Type<br>(ground/1st)                           | <u>LAHC Dwelling</u><br><u>Requirements</u><br>1 bedroom: min<br>50m <sup>2</sup><br>2 bed: min  | No of<br>bedrooms  | POS required<br>m²   | POS proposed<br>m <sup>2</sup>             | Livable Housing<br>Standard/Adaptable etc            |
| ROOMS                  | 1   | Ground   | 70m <sup>2</sup>   | 1  | 15   | 58   | silver   |
|                        | 2   | Ground   | 57   | 1  | 15   | 47   | silver   |
|                        | 3   | First<br>First                                 | 58<br>57   | 1  | 8<br>8   | 8<br>8                                     | silver<br>silver                                     |
|                        | 5   | Ground<br>Ground                               | 58<br>59   | 1  | 15<br>15   | 108<br>51                                  | silver<br>silver                                     |
|                        | 7   | First<br>First                                 | 58<br>59   | 1  | 8  | 8  | silver<br>silver                                     |
|                        | 5   | Control  |  | -  | Requirement  | 5  | Proposed   |
|                        | Housing<br>SEPP   |  |  | Setback to b   | be generally in line   | e with existing                            | Combles Pde:   |
|                        | SEPP<br>Cl. <u>99(e)</u>  | Front Se                                       | athack   |  | building line.   |  | Balconies: 4.4m<br>Walls: 5.17m                      |
| MIN.                   | and   |  | ELDOCK   | or   |  | Hamel Rd:<br>Facade: 5.3m                  |  |
| SETBACKS               | RDCP – MDH  |  |  | 3m   |  | Walls: 6.7m                                |  |
|                        | RDCP - MDH  | Side Se  | tback  |  | 4m<br>uires where setback<br>of devel. to be built                               | s are less than 1.2m<br>to this alignment. | 3.64m – 6m   |
|                        | RDCP - MDH  | Rear Se  | tback  | 25% of allotment depth or 8m, whichever is lesser.   |  | N/A  |  |
| Building<br>Height     | Housing SEPP<br>Cl.108(2)(a), note also 108(2)(b)<br>(SH non-discretionary std)                         |  | 9.5m   |  | 7.5m   |  |  |
| FSR                    | Housing SEPP<br>Cl. 108(2)(c)<br>*Note GFA definition varies from that in LEPs refer<br>to <u>Cl.82</u> |  | 0.5  | 0.5:1<br>x 1201.4m <sup>2</sup> = 600  | .70m²  | 533.74m <sup>2</sup> GFA / 0.44 :1         |  |
| FJK                    |   | Randwick LEP                                   |  | 0.5  | 0.5:1<br>x 1201.4m <sup>2</sup> = 600  | 70m²                                       | 533.74m <sup>2</sup> GFA / 0.44 :1                   |
| LANDSCAPED<br>AREA     |   | Housing SEPP<br><u>Cl. 108(2)(d)</u>           |  | Min. 35m <sup>2</sup> per dwelling<br>35m <sup>2</sup> x 8 = 280m <sup>2</sup>                     |  | 405.08 m <sup>2</sup>                      |  |
|                        |   |  |  | Min. 15% of site   |  |  | 259.42 m² / 21.5%                                    |
|                        |   |  |  |  | x 1201.4m <sup>2</sup> = 180   |  | Min dimension = 3m                                   |
| DEEP SOIL<br>ZONE      |   | Housing SEPP<br><u>Cl. 108(2)(f)</u>           |  |  | Min. 3m dimensio   |  |  |
|                        |   |  | Min. 65% of DSZ to be located at rear of site<br>65% x 247.5m <sup>2</sup> = 160.9m <sup>2</sup> |  | No rear  |  |  |
|                        |   |  |  |  | Mid block %  |  | 97.25 m <sup>2</sup> / 21.5%<br>(of total deep soil) |
|                        |   |  |  | 70% of dwelling  | gs - min 2 hrs betv  | veen Com 9. One                            | 3+ hrs Living Rooms =                                |
| SOLAR<br>ACCESS        |   | Housing SEPP<br>Cl. 108(2)(g)                  |  |  | gs - min 2 hrs betw<br>mid- winter to:<br>iving rooms                            | veen pain & spm                            | 7/8 Dwellings  |
| 700599                 |   | <u> 108(2)(9)</u>                              |  |  | iving rooms<br>rivate open space   |  | 3+hrs POS =<br>8/8 Dwellings                         |
| SOLAR<br>ACCESS –      |   |  |  | Neighbouring Dwellings:<br>- Living Rooms min 3hrs direct sunlight<br>between 9am & 3pm mid winter |  | Living Rooms = no<br>effect                |  |
| ADJOINING<br>DWELLINGS |   | SLUDG  |  |  | ess to private ope<br>ably reduced   | n space not to be                          | POS = 11 combles<br>reduced by 1hr                   |
|                        |   |  |  | <u>Gr</u>  | ound Floor dwelli<br>15m² per dwellin  |  | Complies<br>Refer table above                        |
|                        |   |  |  |  | with min. dimensi  |  | Complies   |
| PRIVATE<br>OPEN SPACE  |   | Housing SEPP<br><u>Cl. 108(2)(h) &amp; (i)</u> |  | Acc  | ings not on groun<br>Provide balcony<br>essible from living<br>1in. Dimension of | garea                                      | Complies   |
|                        |   |  |  |  | its = 6m² (note LA<br>iirements require  |  | Complies<br>Refer table above                        |
| CAR<br>PARKING         |   | AHC requirement<br>on accessible rate          |  |  | 4 spaces r'qd<br>1-bed: 8 x 0.5 = 4  | 1  | 4 Spaces   |
|                        | <u> </u>  |  |  |  |  |  | · ·  |

|                    | Housing SEPP<br><u>Cl.108(2)(j)</u>               | 1 space per 5 dwellings<br>8 ÷ 5 = (1.6) 2<br>*Note Carpark to also be designed in accordance with<br>SLUDG criteria  | 4 Spaces   |
|--------------------|---|---|--|
|                    | Housing SEPP<br><u>Schedule 4</u>                 | 10% of the total number of car parking spaces (or<br>at least one space if there are fewer than 10<br>spaces) must be designed to enable the width of<br>the spaces to be increased to 3.8 metres | 1 space<br>(carport capable)                                   |
|                    | Housing SEPP                                      | 1 space per 5 dwelling (Accessible Spaces)<br>8 ÷ 5 = (1.6) 2   | 2 spaces   |
| TREE<br>REMOVAL    | Housing SEPP<br>Cl. <u>99(a)</u>                  | Retain, wherever reasonable, significant trees<br>No. of trees on site & in close proximity to<br>development = 8   | No. of significant trees<br>= 8<br>Retained = 5<br>Removed = 3 |
|                    | DDCD.   | Waste Generation Rates:<br>Waste – 240L p/wk per 2 dwellings = 240L x 4 =<br>960L<br>Recycling – 240L p/fn per 2 dwellings = 240L x 4 =   | 6  |
| WASTE              | RDCP  | 960L<br>Green – 240L p/fn per dwelling (Only applies to<br>multi dwelling housing that generate garden<br>organics) = 240L x 4 = 960L   | 6  |
| ADAPTABLE<br>UNITS | LAHC Dwelling Requirements<br>Adaptable Dwellings | AS 4299 Class C adaptable dwellings to be provided as required by LAHC project brief  | None required by<br>LAHC brief                                 |

|                                  | NCC 2022                         | NatHERS Thermal Perform   | ance Specification - Matraville  |
|----------------------------------|----------------------------------|---|--|
|                                  |                                  | External W  | lalls  |
| Wall Type                        | Insulation                       | Colour  | Comments   |
| Cavity Brick                     | R0.7                             | Med - SA 0.475 - 0.70   | Ground and Level 1   |
| FC cladding                      | R0.7                             | Med - SA 0.475 - 0.70   | Lobby  |
|                                  |                                  | SA - Solar Absc   | orptance   |
|                                  |                                  | Internal W  | alls   |
| Wall Type                        | Insulation                       |   | Comments   |
| Single skin brick                | None                             | Inte  | ernally in units on ground floor (Throughout except below)                               |
| Single skin brick                | R1.0                             |   | Internal walls of Bath (Unit 5 only)   |
| Plasterboard stud                | None                             |   | Internally in units on Level 1   |
| Cavity brick with plasterboard   | None                             |   | Party walls between units  |
| Cavity brick with plasterboard   | None                             | S   | hared walls with lobby/stairs (Throughout except below)                                  |
| Cavity brick with plasterboard   | R0.7                             |   | Shared walls with lobby/stairs (Unit 5 only)   |
|                                  |                                  | Floors  |  |
| Floor Type                       | Insulation                       |   | Comments   |
| Concrete slab on ground          | None                             |   | Ground floor units   |
| Concrete                         | None                             |   | Level 1 units  |
|                                  |                                  | Ceilings  |  |
| Ceiling Type                     | Insulation                       | Comments  |  |
| Plasterboard                     | None                             | Unit above  |  |
| Plasterboard                     | R2.5                             | Roof/air above  |  |
| Insulation loss due to downlight | s has <u>not</u> been modelled i | in this assessment. A sealed  | exhaust fan has been included in every kitchen, bathroom, laundry and ensuite.           |
|                                  |                                  | Roof  |  |
| Roof Type                        | Insulation                       | Colour Comments   |  |
| Metal                            | R1.3 foil-faced blanket          | t Med - SA 0.475 - 0.70 Throughout (Unvented cavity)                  |  |
|                                  |                                  | SA - Solar Abso   | prptance   |
|                                  |                                  | Glazing   |  |
| Opening type                     | U-Value                          | SHGC  | Glazing & Frame Type   |
| Sliding + Fixed (Throughout)     | 4.8                              | 0.59 e.g., Single glazed high-performance low-e clear Aluminium frame |  |
| Awning (Throughout)              | 4.8                              | 0.51 e.g., Single glazed high-performance low-e clear Aluminium frame |  |
| U and SHGC values are based on t | he AFRC Default Windows          | Set. Glazing systems to be in specified val                           | nstalled must have an equal or lower U value and a SHGC value $\pm$ 10% of the abo lues. |
|                                  |                                  | Skylight  | s  |
| Skylight Type                    | Fram                             | е Туре  | Comments   |
| na                               |                                  | na  | na   |
|                                  | •                                | Ceiling fa  | n  |
| Size                             | Loc                              | ation   | Comments   |
|                                  |                                  |   |  |

**Certificate Prepared by** Greenview Consulting Pty Ltd ABN: 32600067338 Email: dean@greenview.net.au Phone: 0404 649 762 Stanton Dahl & Associates Pty Limited. ABN 32 002 261 396 Nominated Architects : D.M Bell 11076, S.M Evans 7686 © Copyright 2023 Stanton Dahl

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| DA1  | Part 5 Issue       | 28/09/23 |
| DA2  | Part 5 Issue       | 25/10/23 |







LAHC

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Scale; as noted @ AI

Project No; 2701.21

Drawing No; DA04

LAHC Project No; BGXPR


Revision#; DA2

Development Data & Notes



0008956900 28 Sep 2023 Assessor Dean Gorman ddress Matraville, NSW, 2036

ccreditation No. DMN/13/1645 amel 15-17 Combles Pde 2-4 Hamel

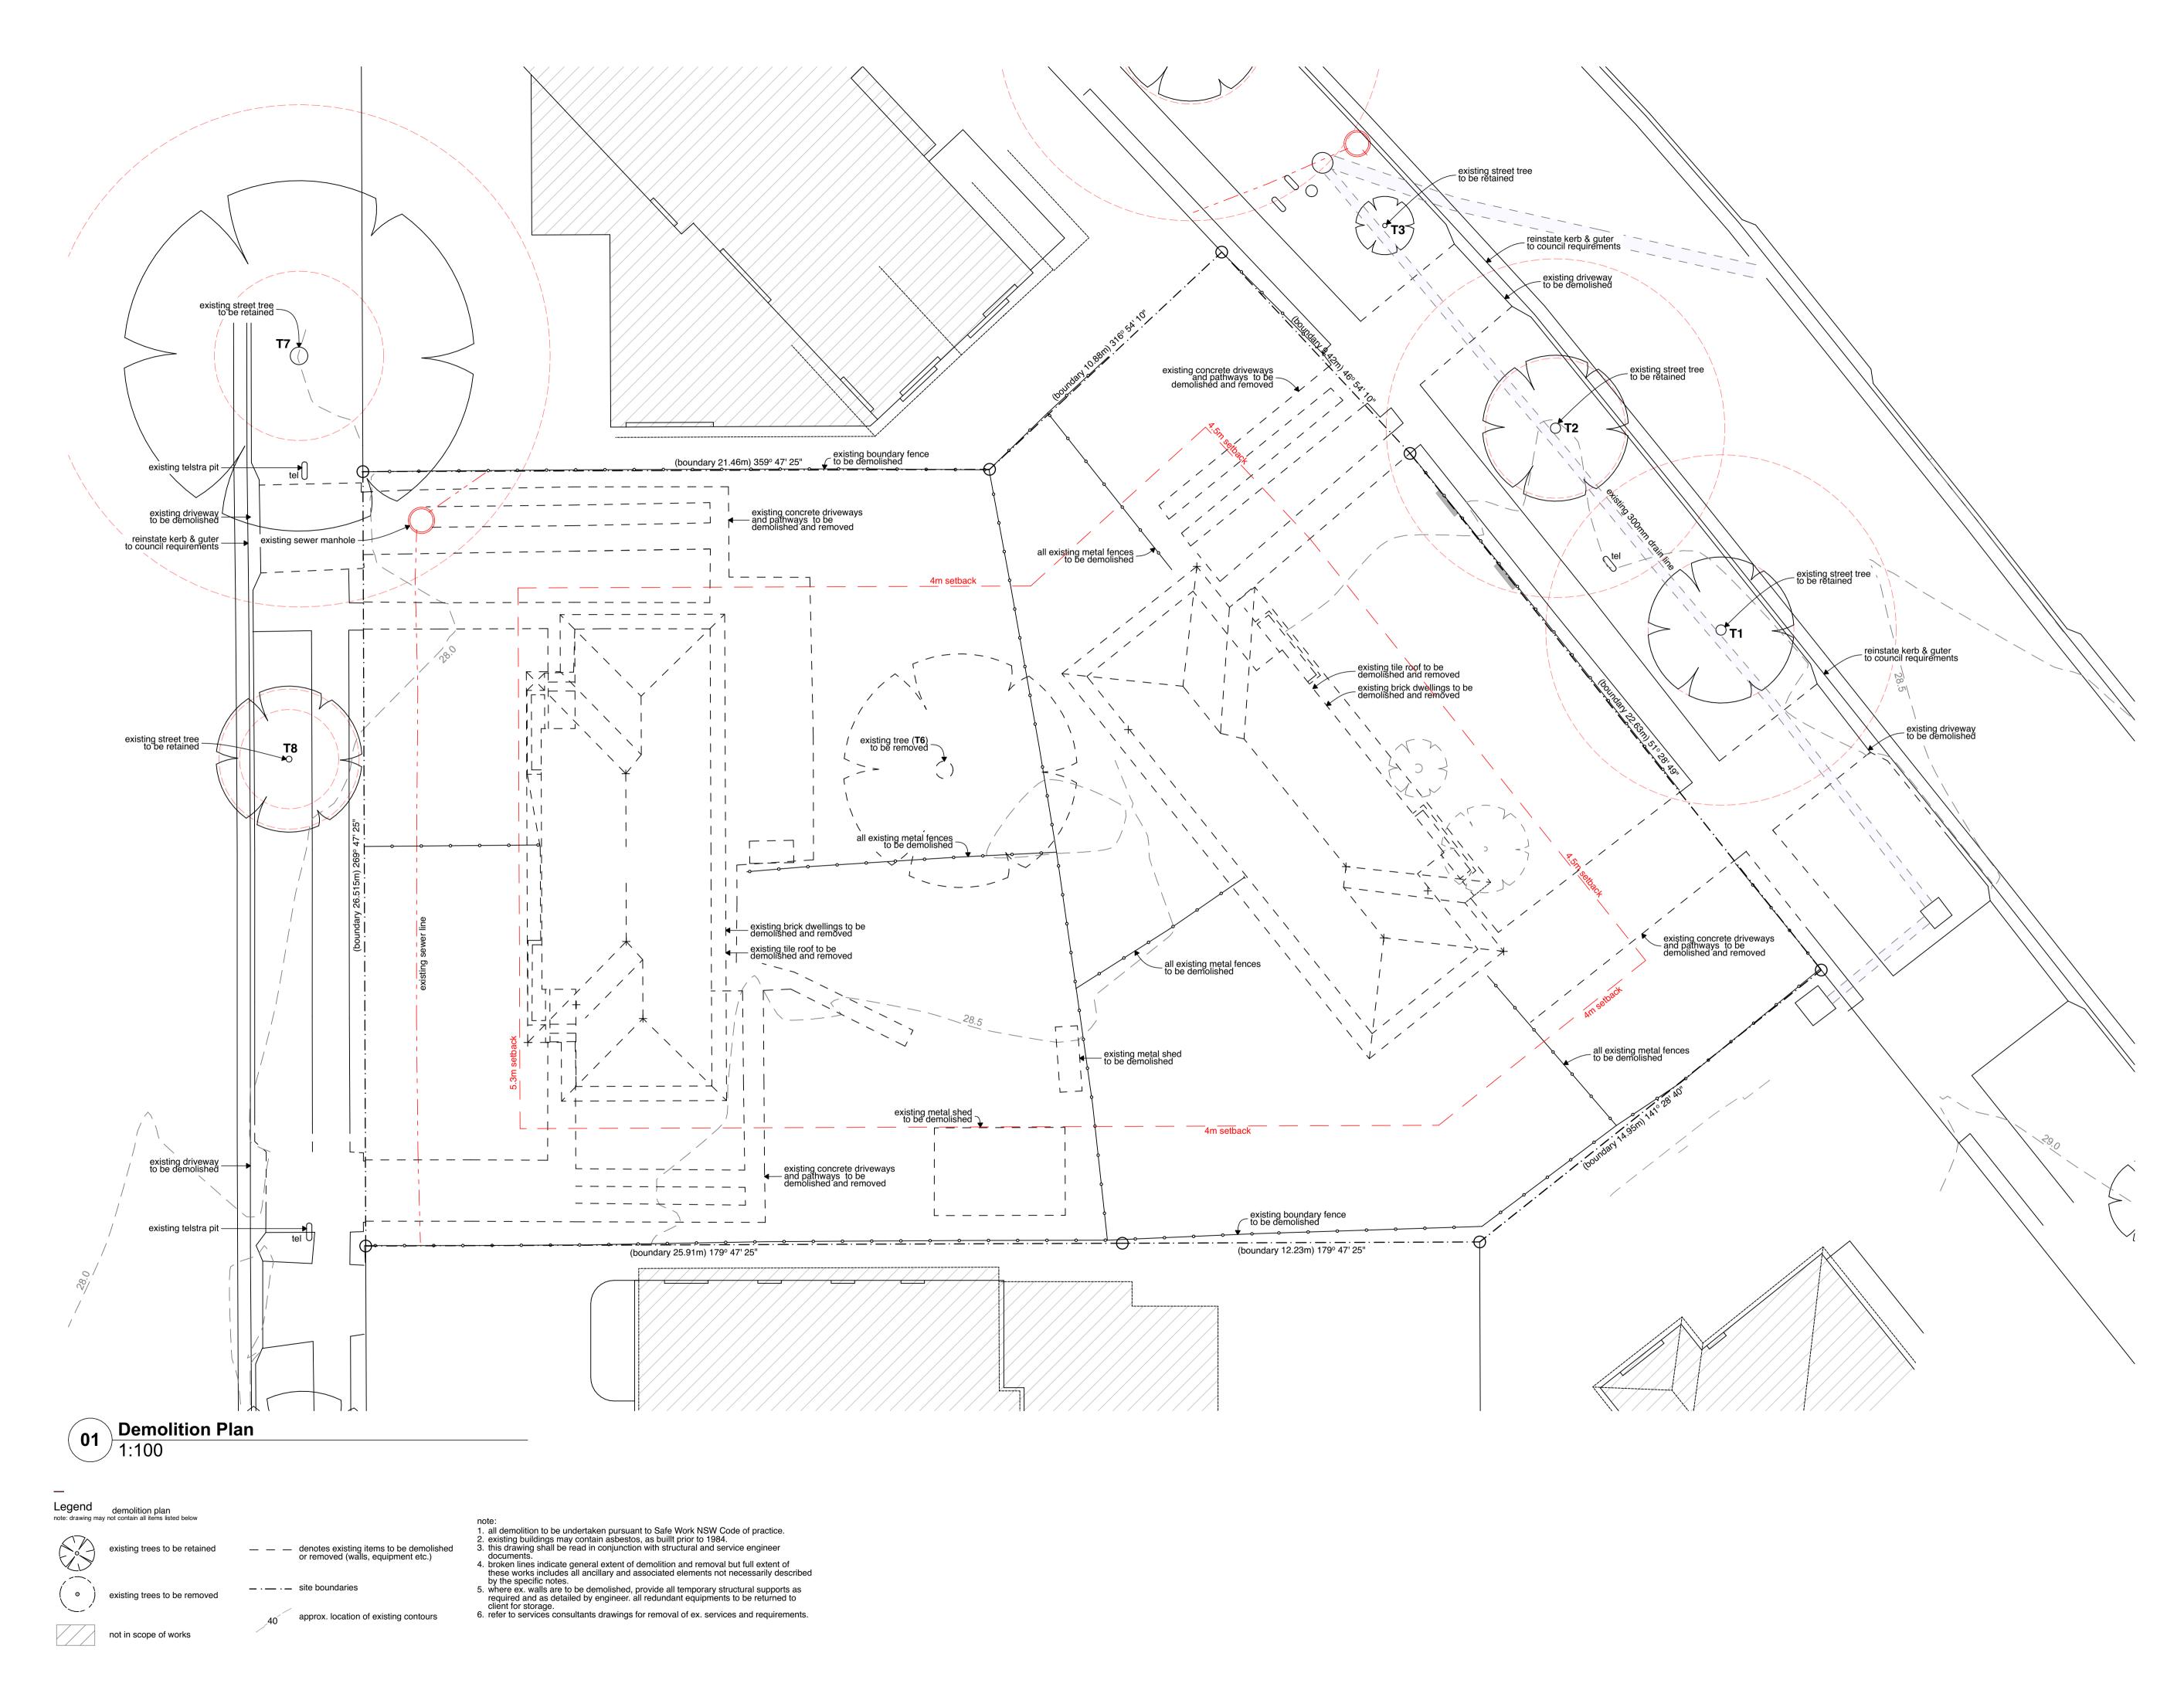

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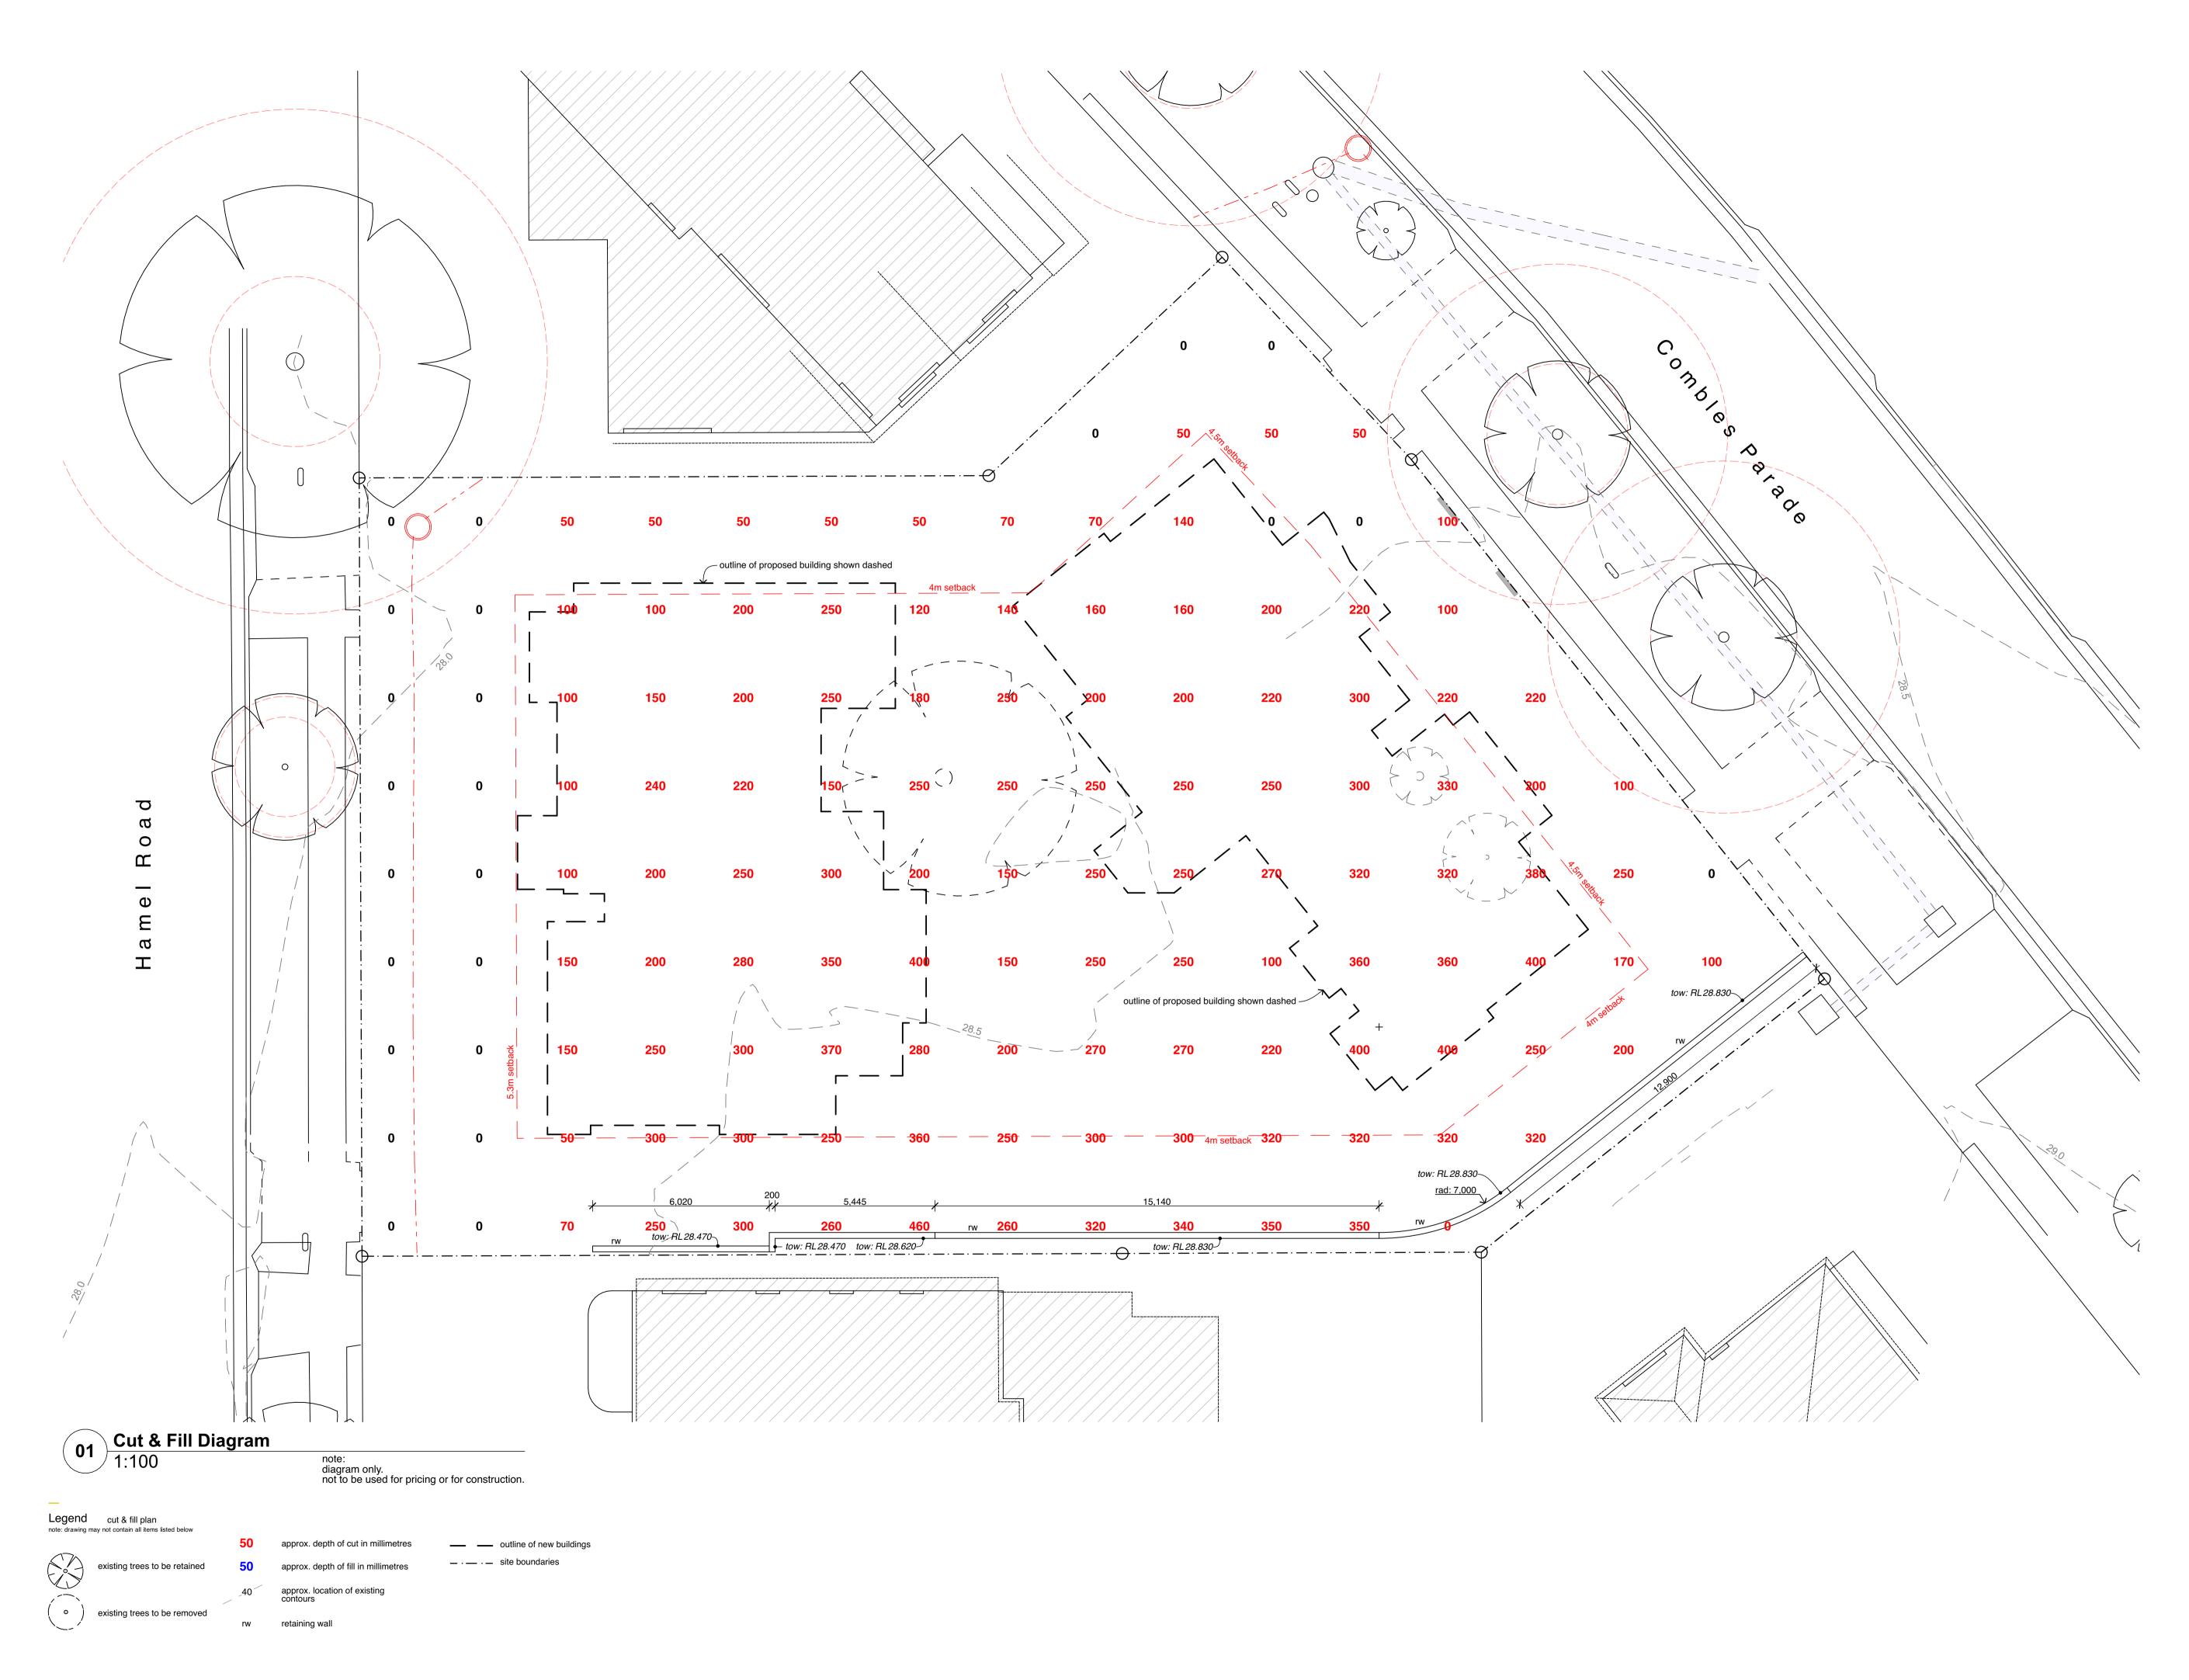
Drawing No;

DA05

LAHC Project No; BGXPR

Revision#; DA2

Demolition Plan



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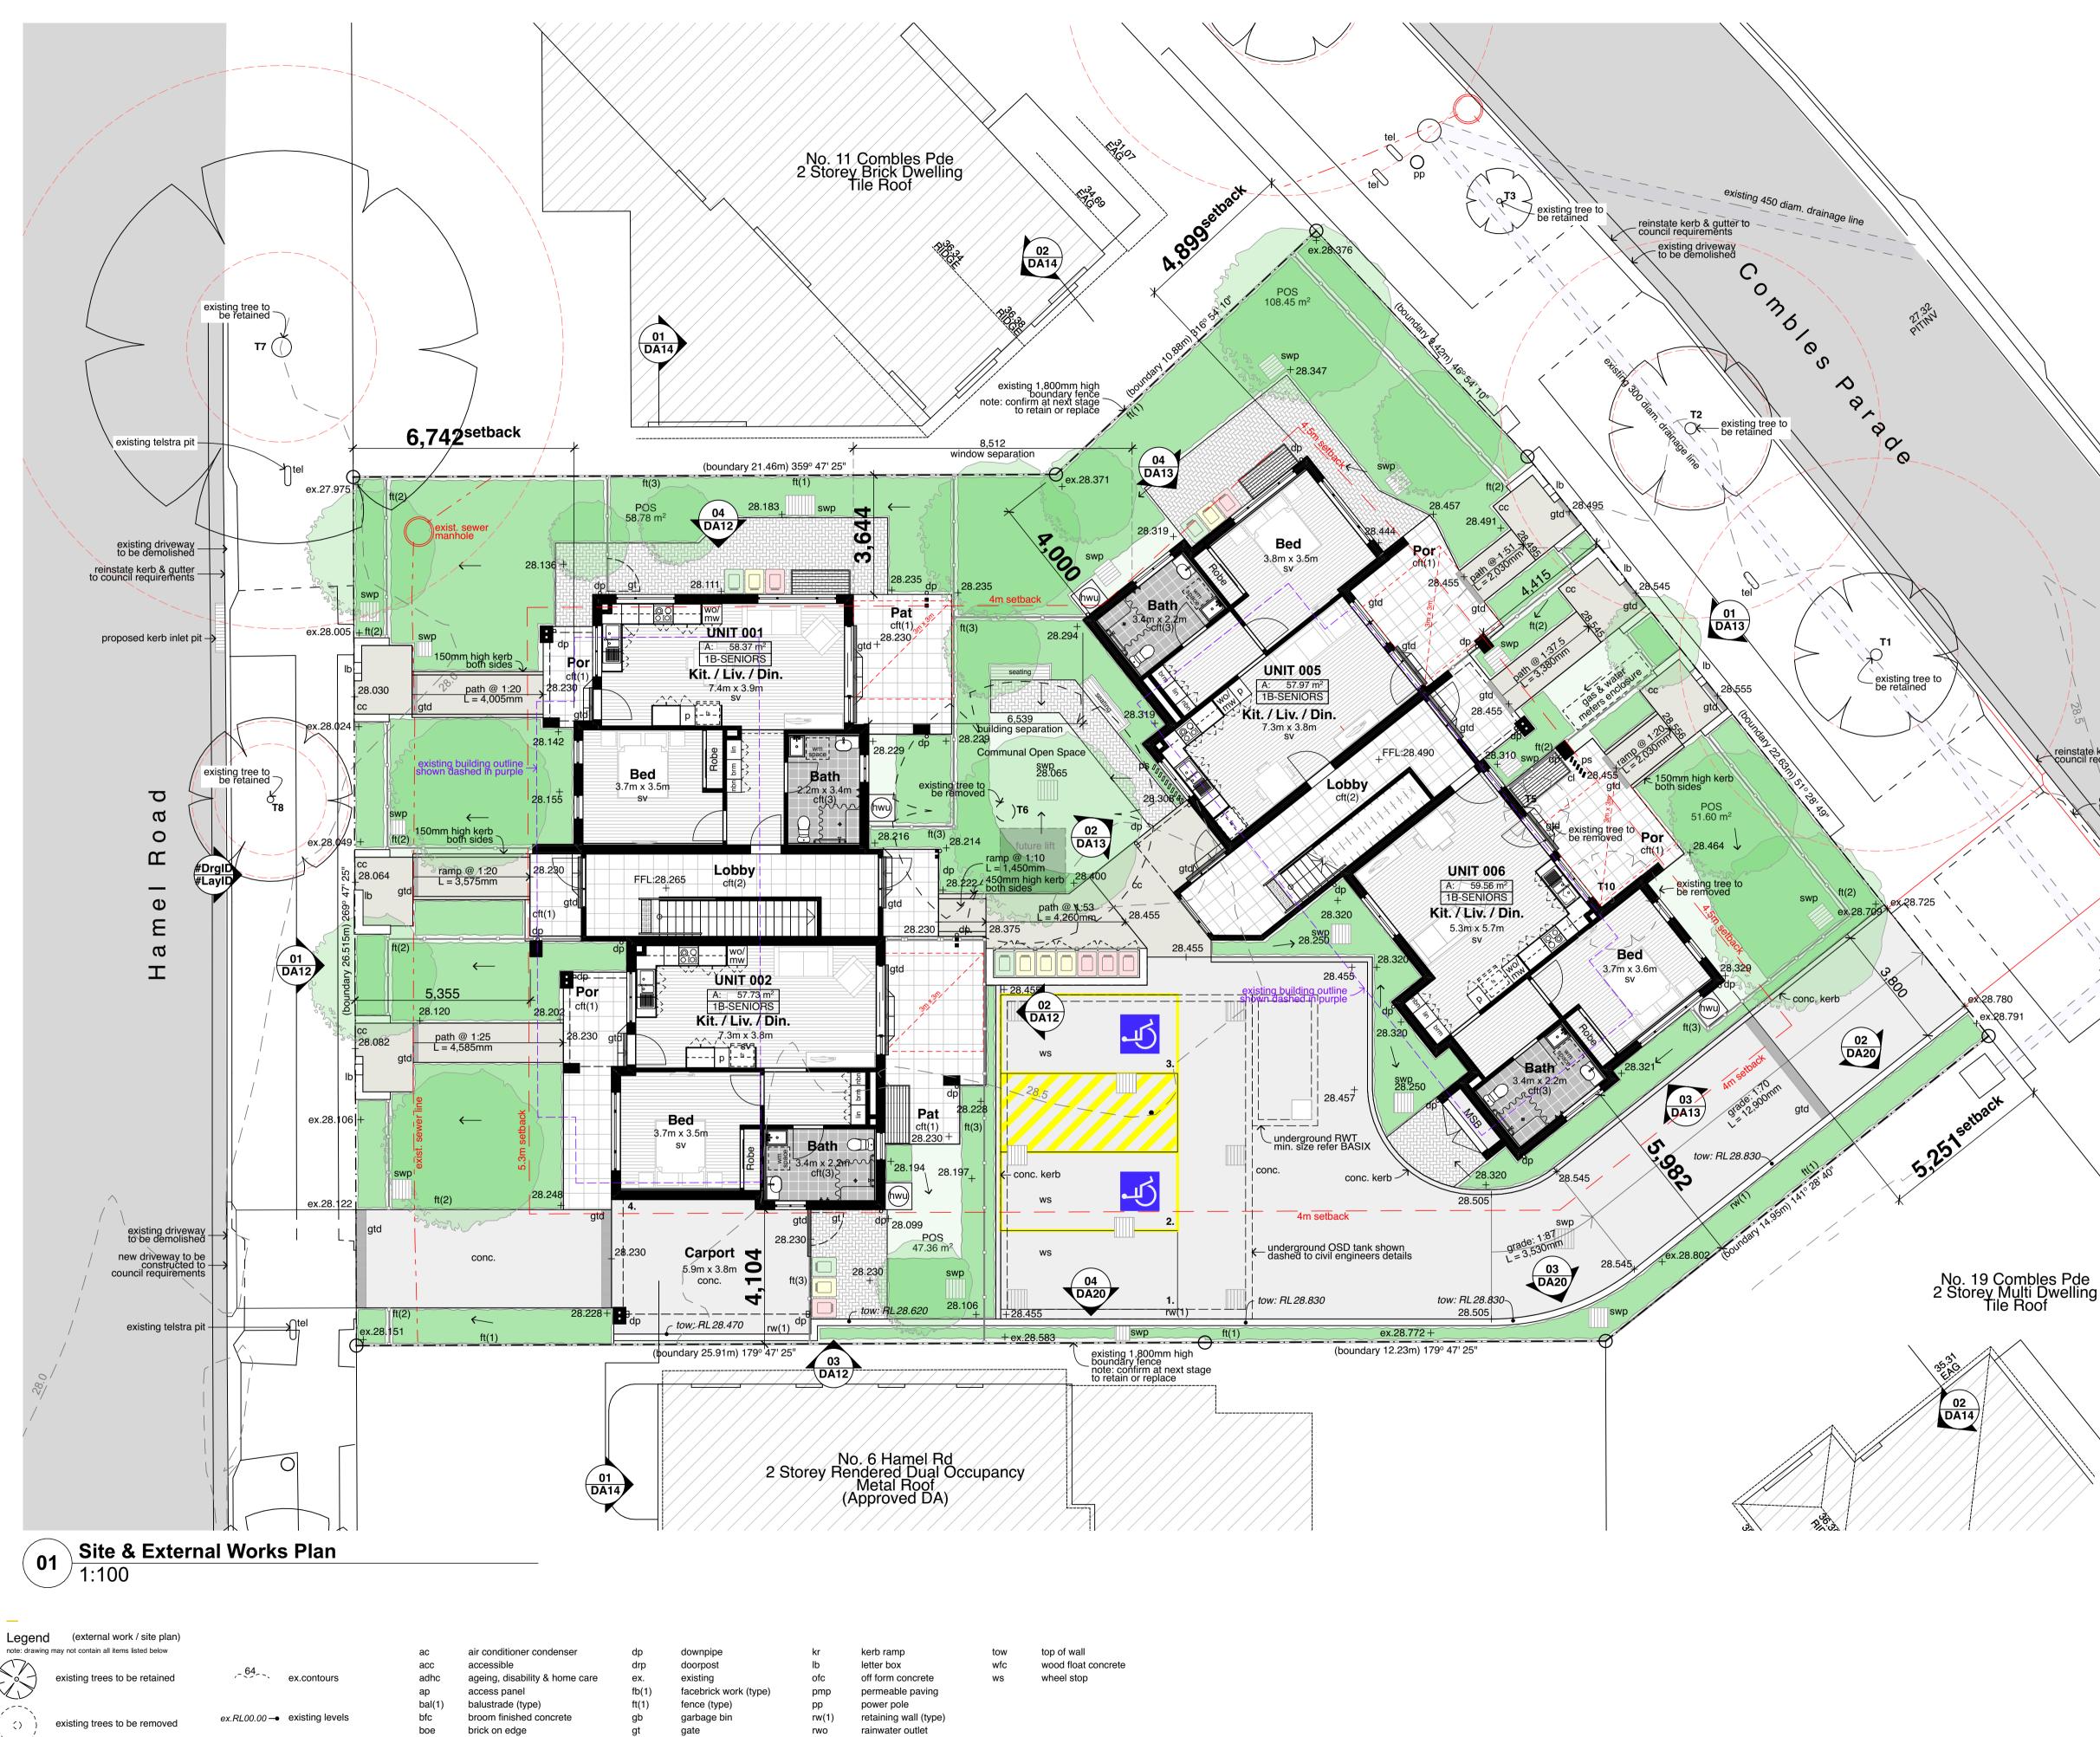
Drawing No;

DA06

LAHC Project No; BGXPR

Revision#; DA2

Cut & Fill Diagram



proposed new trees

RL00.00 - proposed levels proposed spot levels (ffl) 39.000

cc(1) cft(1) cl col

bol

bollard coloured concrete (type) ceramic floor tile (type) clothes line column

grated drain

hose tap

hydrant

handrail (type)

hot water unit

hr(1)

ht

hwu

hyd

rainwater tank

storm water pit

swp

tgsi

steel float concrete

trowel finished concrete

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reinstate kerb & gutter to council requirements

existing driveway

new driveway to be constructed to council requirements





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Drawing No;

DA07

LAHC Project No; BGXPR

Revision#; DA2

Site & Ground Floor Plan



col

column

hyd

hydrant

tgsi

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# LAHC

Seniors living Development (x8 Units) 15-17 Combles Pde & 2-4 Hamel Rd, Matraville, NSW Drawn; CP Checked; AT Plot date; 23/10/23

Scale;1:100 as noted @ AI

Project No; 2701.21

Drawing No;


DA08

LAHC Project No; BGXPR

Revision#; DA2

Site & First Floor Plan

reinstate kerb & gutter to council requirements new driveway to be constructed to council requirements

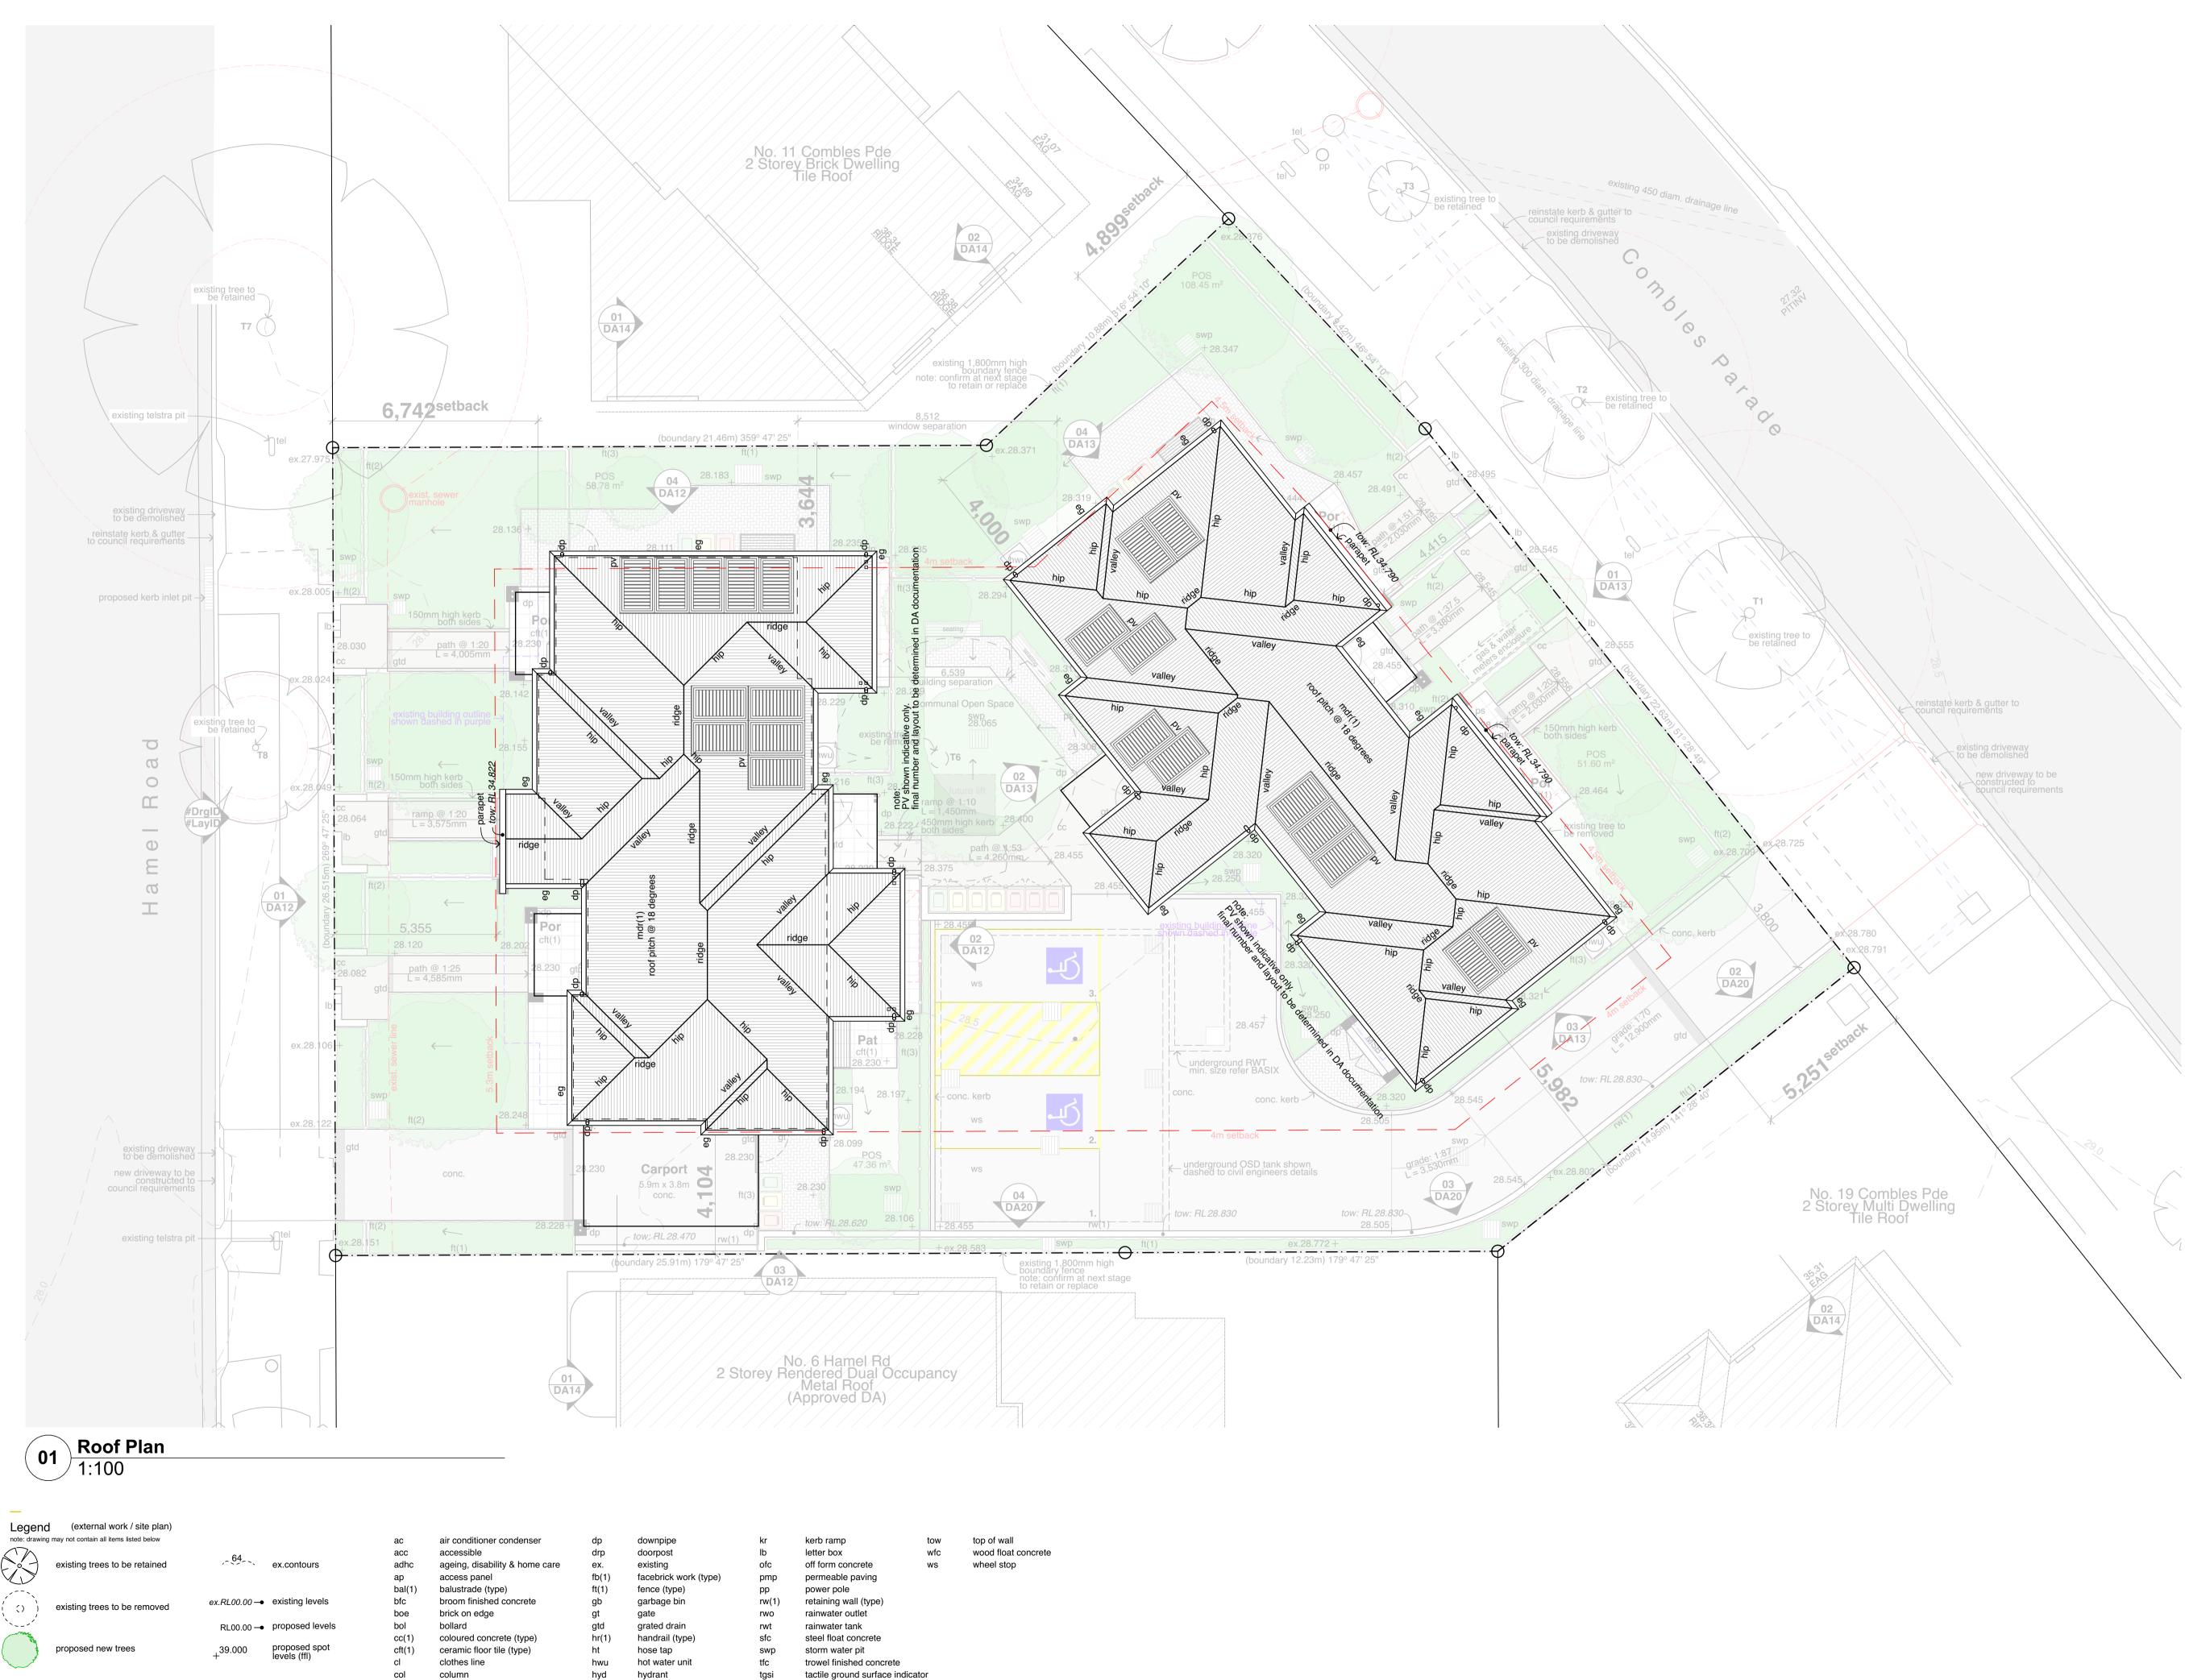

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| Rev  | Issue              | Date     |
|------|--------------------|----------|
| DAP1 | Draft Part 5 Issue | 19/09/23 |
| DA1  | Part 5 Issue       | 28/09/23 |
| DA2  | Part 5 Issue       | 25/10/23 |









LAHC

Seniors living Development (x8 Units) 15-17 Combles Pde & 2-4 Hamel Rd, Matraville, NSW Drawn; CP Checked; AT Plot date; 23/10/23

Scale;1:100 as noted @ AI

Project No; 2701.21

Drawing No;

DA09


LAHC Project No; BGXPR

Revision#; DA2

Site & Roof Plan

#### scale: 1:100 @A1

|     | Window Schedule |        |                         |   |          |  |  |  |
|-----|-----------------|--------|-------------------------|---|----------|--|--|--|
| ld  | Width           | Height | W/D Nominal Sill Height | Door/Window Type                                    | Quantity |  |  |  |
| W1  | 1,570           | 1,200  | 1,200                   | Aluminium Frame Sliding                             | 6        |  |  |  |
| W2  | 730             | 2,100  | 300                     | Aluminium Frame Top Hung + Fixed Bottom Sash        | 10       |  |  |  |
| W3  | 2,410           | 600    | 900                     | Aluminium Frame Fixed x2 Top Hung + x1 Fixed Sash   | 4        |  |  |  |
| W4  | 2,410           | 600    | 1,800                   | Aluminium Frame x3 Fixed Sash                       | 11       |  |  |  |
| W5  | 970             | 944    | 1,456                   | Aluminium Frame Sliding (Opaque)                    | 1        |  |  |  |
| W6  | 850             | 600    | 1,800                   | Aluminium Frame Fixed (Opaque)                      | 1        |  |  |  |
| W7  | 580             | 2,400  | 0                       | Aluminium Frame Fixed Sash                          | 1        |  |  |  |
| W8  | 850             | 944    | 1,456                   | Aluminium Frame Sliding (Opaque)                    | 3        |  |  |  |
| W9  | 800             | 2,400  | 0                       | Aluminum Frame Fixed Sash                           | 1        |  |  |  |
| W10 | 1,810           | 600    | 900                     | Aluminium Frame x2 Fixed Sash                       | 2        |  |  |  |
| W11 | 1,560           | 2,400  | 200                     | Aluminium Frame Fixed                               | 1        |  |  |  |
| W12 | 1,450           | 944    | 1,456                   | Aluminium Frame Sliding (Opaque)                    | 5        |  |  |  |
| W13 | 1,560           | 2,400  | 0                       | Aluminium Frame Top Hung + Fixed Side & Bottom Sash | 1        |  |  |  |
| W14 | 850             | 2,100  | 300                     | Aluminium Frame Top Hung + Fixed Bottom Sash        | 4        |  |  |  |
| W15 | 1,450           | 1,200  | 1,200                   | Aluminium Frame Sliding                             | 2        |  |  |  |
| W16 | 1,440           | 2,400  | 0                       | Aluminium Frame Top Hung + Fixed Side & Bottom Sash | 1        |  |  |  |
| W17 | 1,570           | 1,310  | 1,090                   | Aluminium Frame Sliding                             | 2        |  |  |  |
| W18 | 1,440           | 2,400  | 0                       | Aluminium Frame Fixed                               | 1        |  |  |  |
| W19 | 1,560           | 2,400  | 0                       | Aluminium Frame Top Hung + Fixed Side & Bottom Sash | 1        |  |  |  |
| W20 | 970             | 1,310  | 1,090                   | Aluminium Frame Sliding                             | 1        |  |  |  |

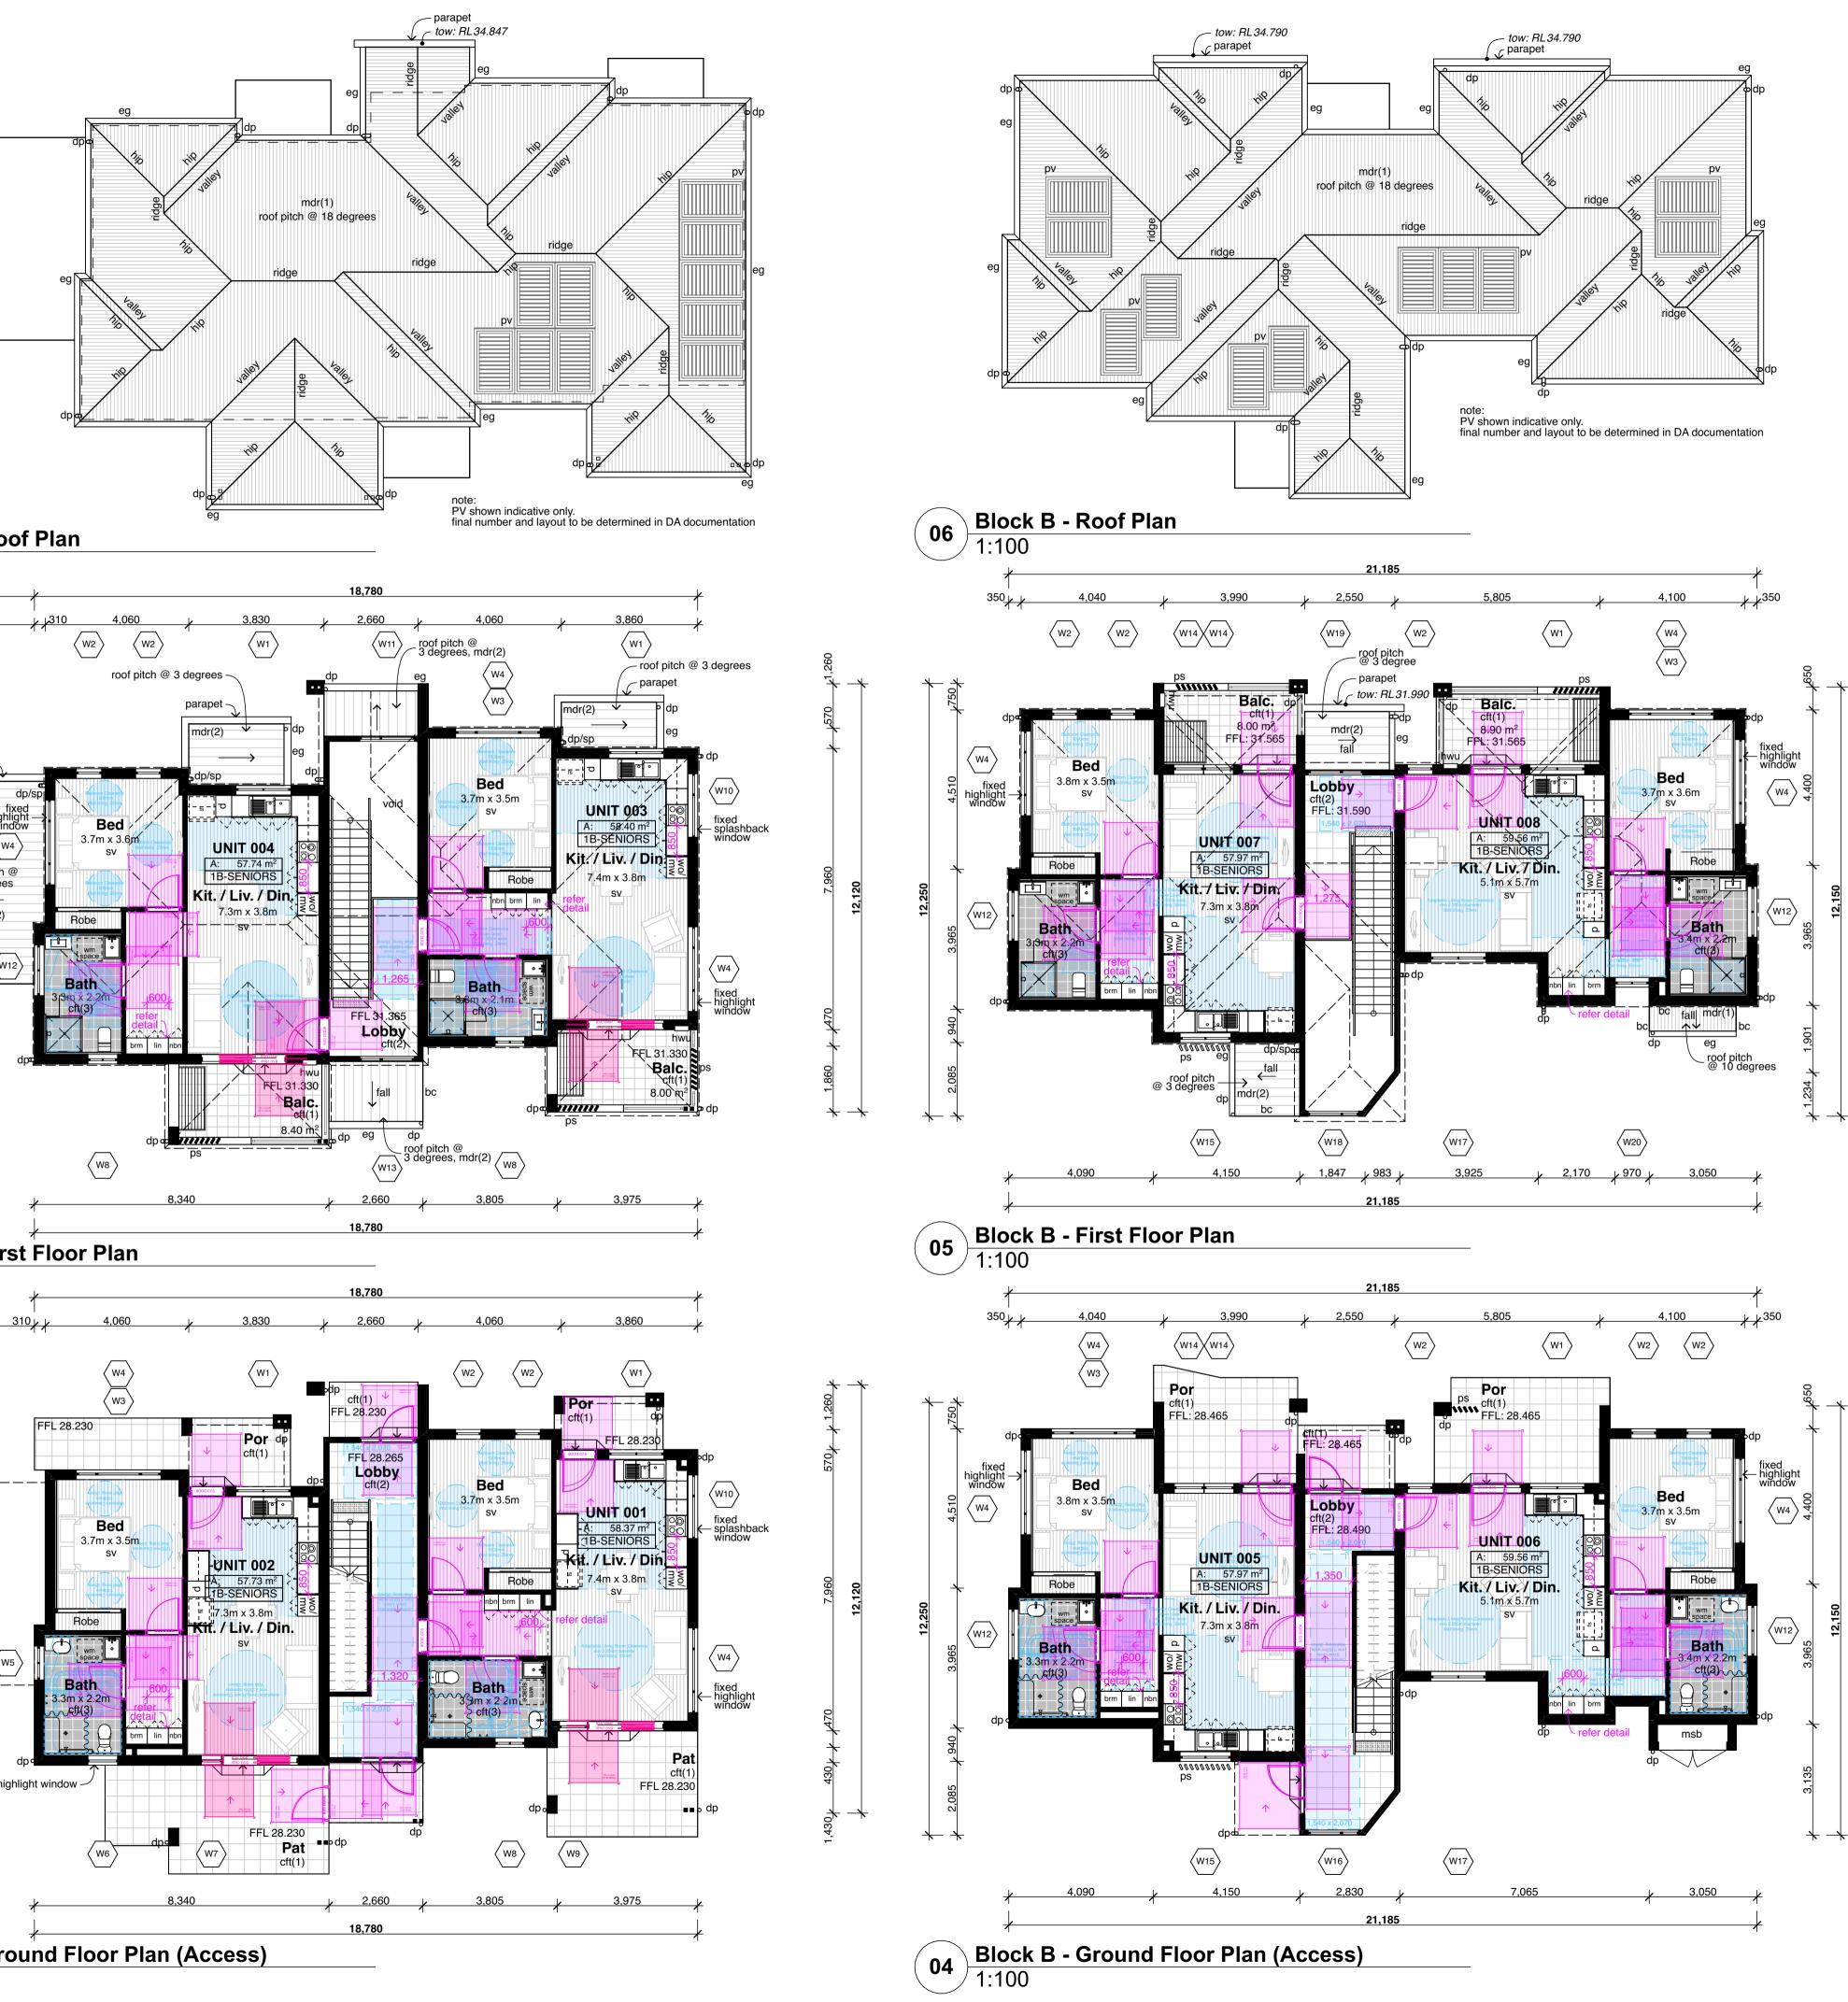

#### Legend (floor plans) note: drawing may not contain all items listed below

#### (D01) door numbers (as scheduled) (prefix ex. for existing door)

#### window numbers (as scheduled) (W01) (prefix ex. for existing window)

(a) — wall type (as scheduled)


| (a) <b>→</b> | wall type (as scheduled)          |
|--------------|-----------------------------------|
| ac           | air conditioner condenser         |
| acc          | accessible                        |
| adhc         | ageing, disability & home care    |
| amb          | ambulant                          |
| ар           | access panel                      |
| bal(1)       | balustrade (type)                 |
| bfc          | broom finish concrete             |
| bol          | bollard                           |
| brm          | broom cupboard                    |
| bsn          | basin                             |
| cft(1)       | ceramic floor tile (type)         |
| cj           | control joint                     |
| cl           | clothes line                      |
| col          | column                            |
| comms        | communication cabinet             |
| cpt(1)       | carpet (type)                     |
| ct           | cooktop                           |
| dp           | downpipe                          |
| drp          | doorpost                          |
| edb          | electrical distribution box       |
| ex.          | existing                          |
| fb(1)        | face brickwork (type)             |
| fhr          | fire hose reel                    |
| fm           | floor mat                         |
| fp           | feature panel                     |
| fs           | fridge space                      |
| fw           | floor waste                       |
| gb           | garbage bin                       |
| gt           | gate                              |
| gtd          | grated drain                      |
| hr(1)        | handrail (type)                   |
| ht           | hose tap                          |
| hwu          | hot water unit                    |
| hyd          | hydrant                           |
| kr<br>Ib     | kerb ramp<br>letter box           |
| lin          | linen cupboard                    |
| mw           | microwave                         |
| ofc          | off form concrete                 |
| pmp          | permeable paving                  |
| pmp<br>ps    | privacy screen                    |
| ps           | pantry                            |
| robe         | wardrobe                          |
| rw(1)        | retaining wall (type)             |
| rwt          | rainwater tank                    |
| snk          | sink                              |
| SC           | steel column                      |
| sfc          | steel float concrete              |
| shr          | shower                            |
| sk           | skylight/skytube                  |
| sl           | sliding door                      |
| st           | store                             |
| sv(1)        | sheet vinyl (type)                |
| swp          | storm water pit                   |
| tgsi         | tactile ground surface indicators |
| vp           | vent pipe                         |
| wfc          | wood float concrete               |
| wm           | washing machine space             |
| WO           | wall oven                         |
| WS           | wheel stop                        |
| WCS          | window casing                     |
|              |                                   |


(window & door schedule)

note:

- 1. dimensions are typically to wall openings unless noted otherwise.
- all door/window openings are to be site measured prior to any fabrication of frames.
   check measure against structural layout.
- check measure against structural layout.
   please read in combination with all other documentation and schedules. plans take priority on door swings.
   refer any discrepancies to the architect for further information.
   flyscreens to all operable windows unless specified
- specified. 7. door sills and window subsill as specified, and
- detailed in sections. 8. all 870 door leaf or greater doors are to be supplied and installed to comply with AS1428.1
- disabled access standard. door grilles have not been shown for clarity - refer to mechanical engineer's details.
   refer to specification for basix/ section j details of all external windows & doors.
   all existing doors nominated as undercut to be coordinated with mechanical engineer's

- coordinated with mechanical engineer's documentation. 12.colorbond preformed cover plate to all columns
- engaged to the glazing systems where necessary. 13.refer to external finishes schedule for metal cladding.

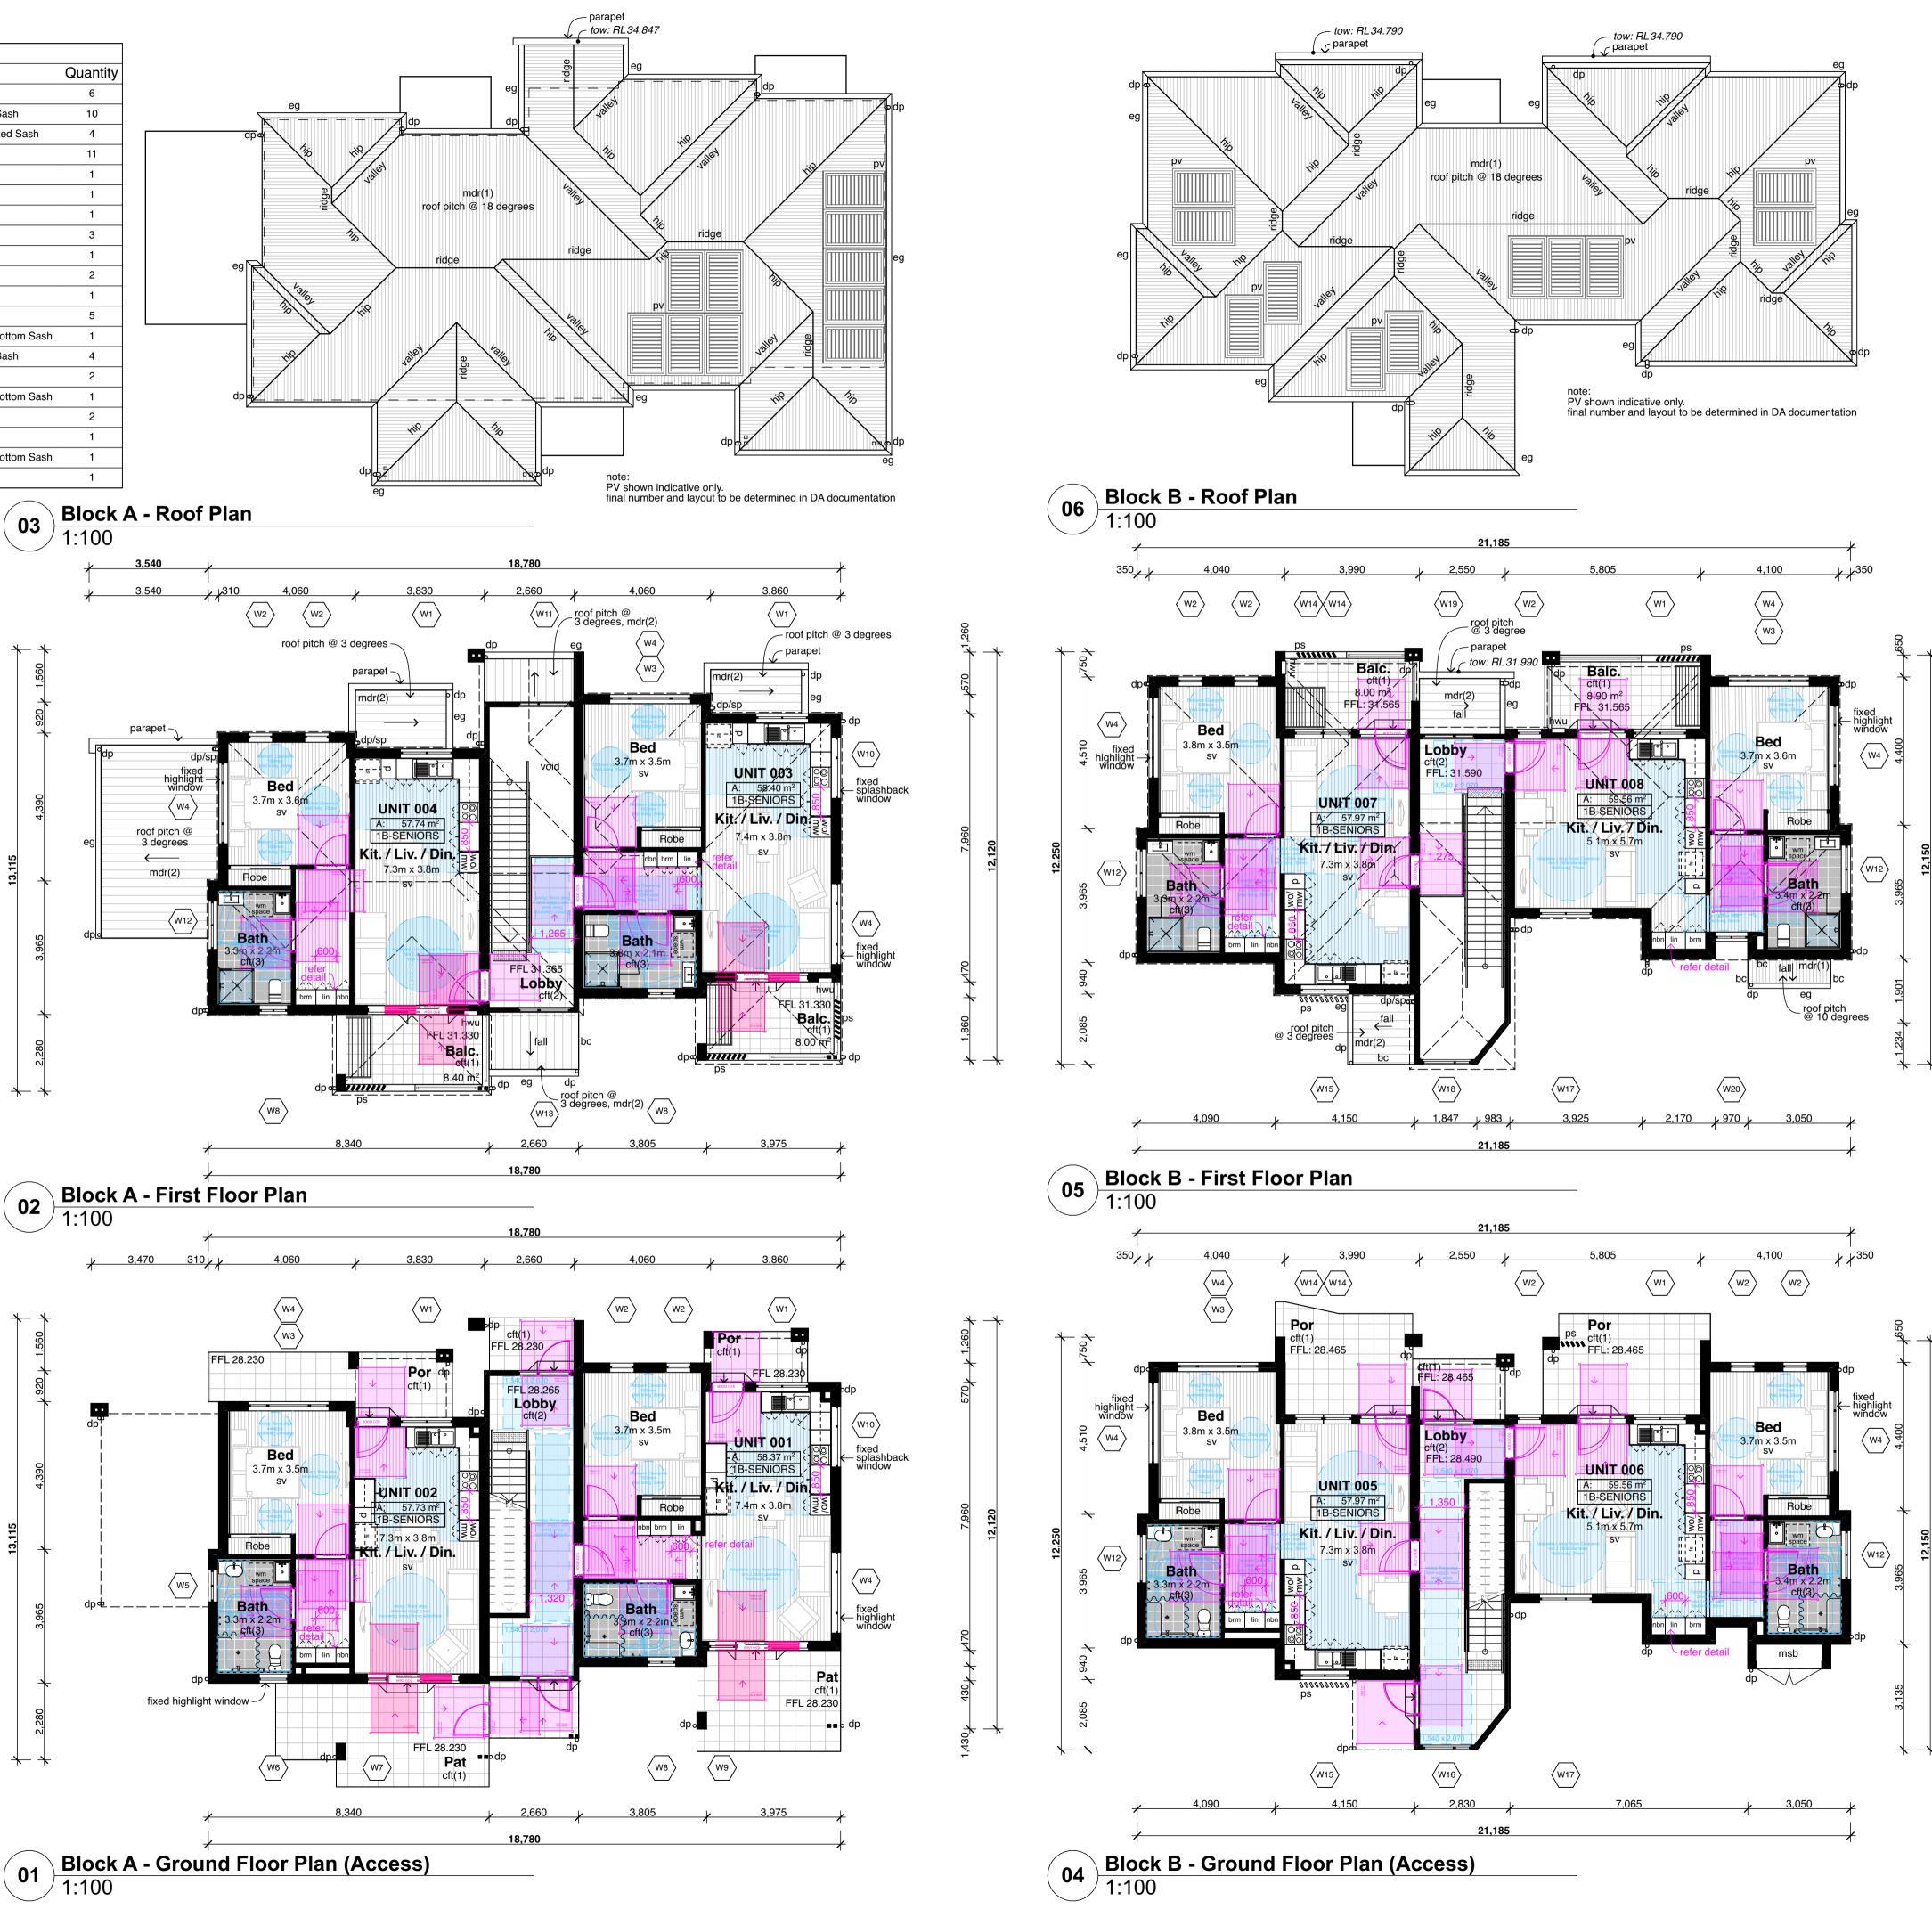

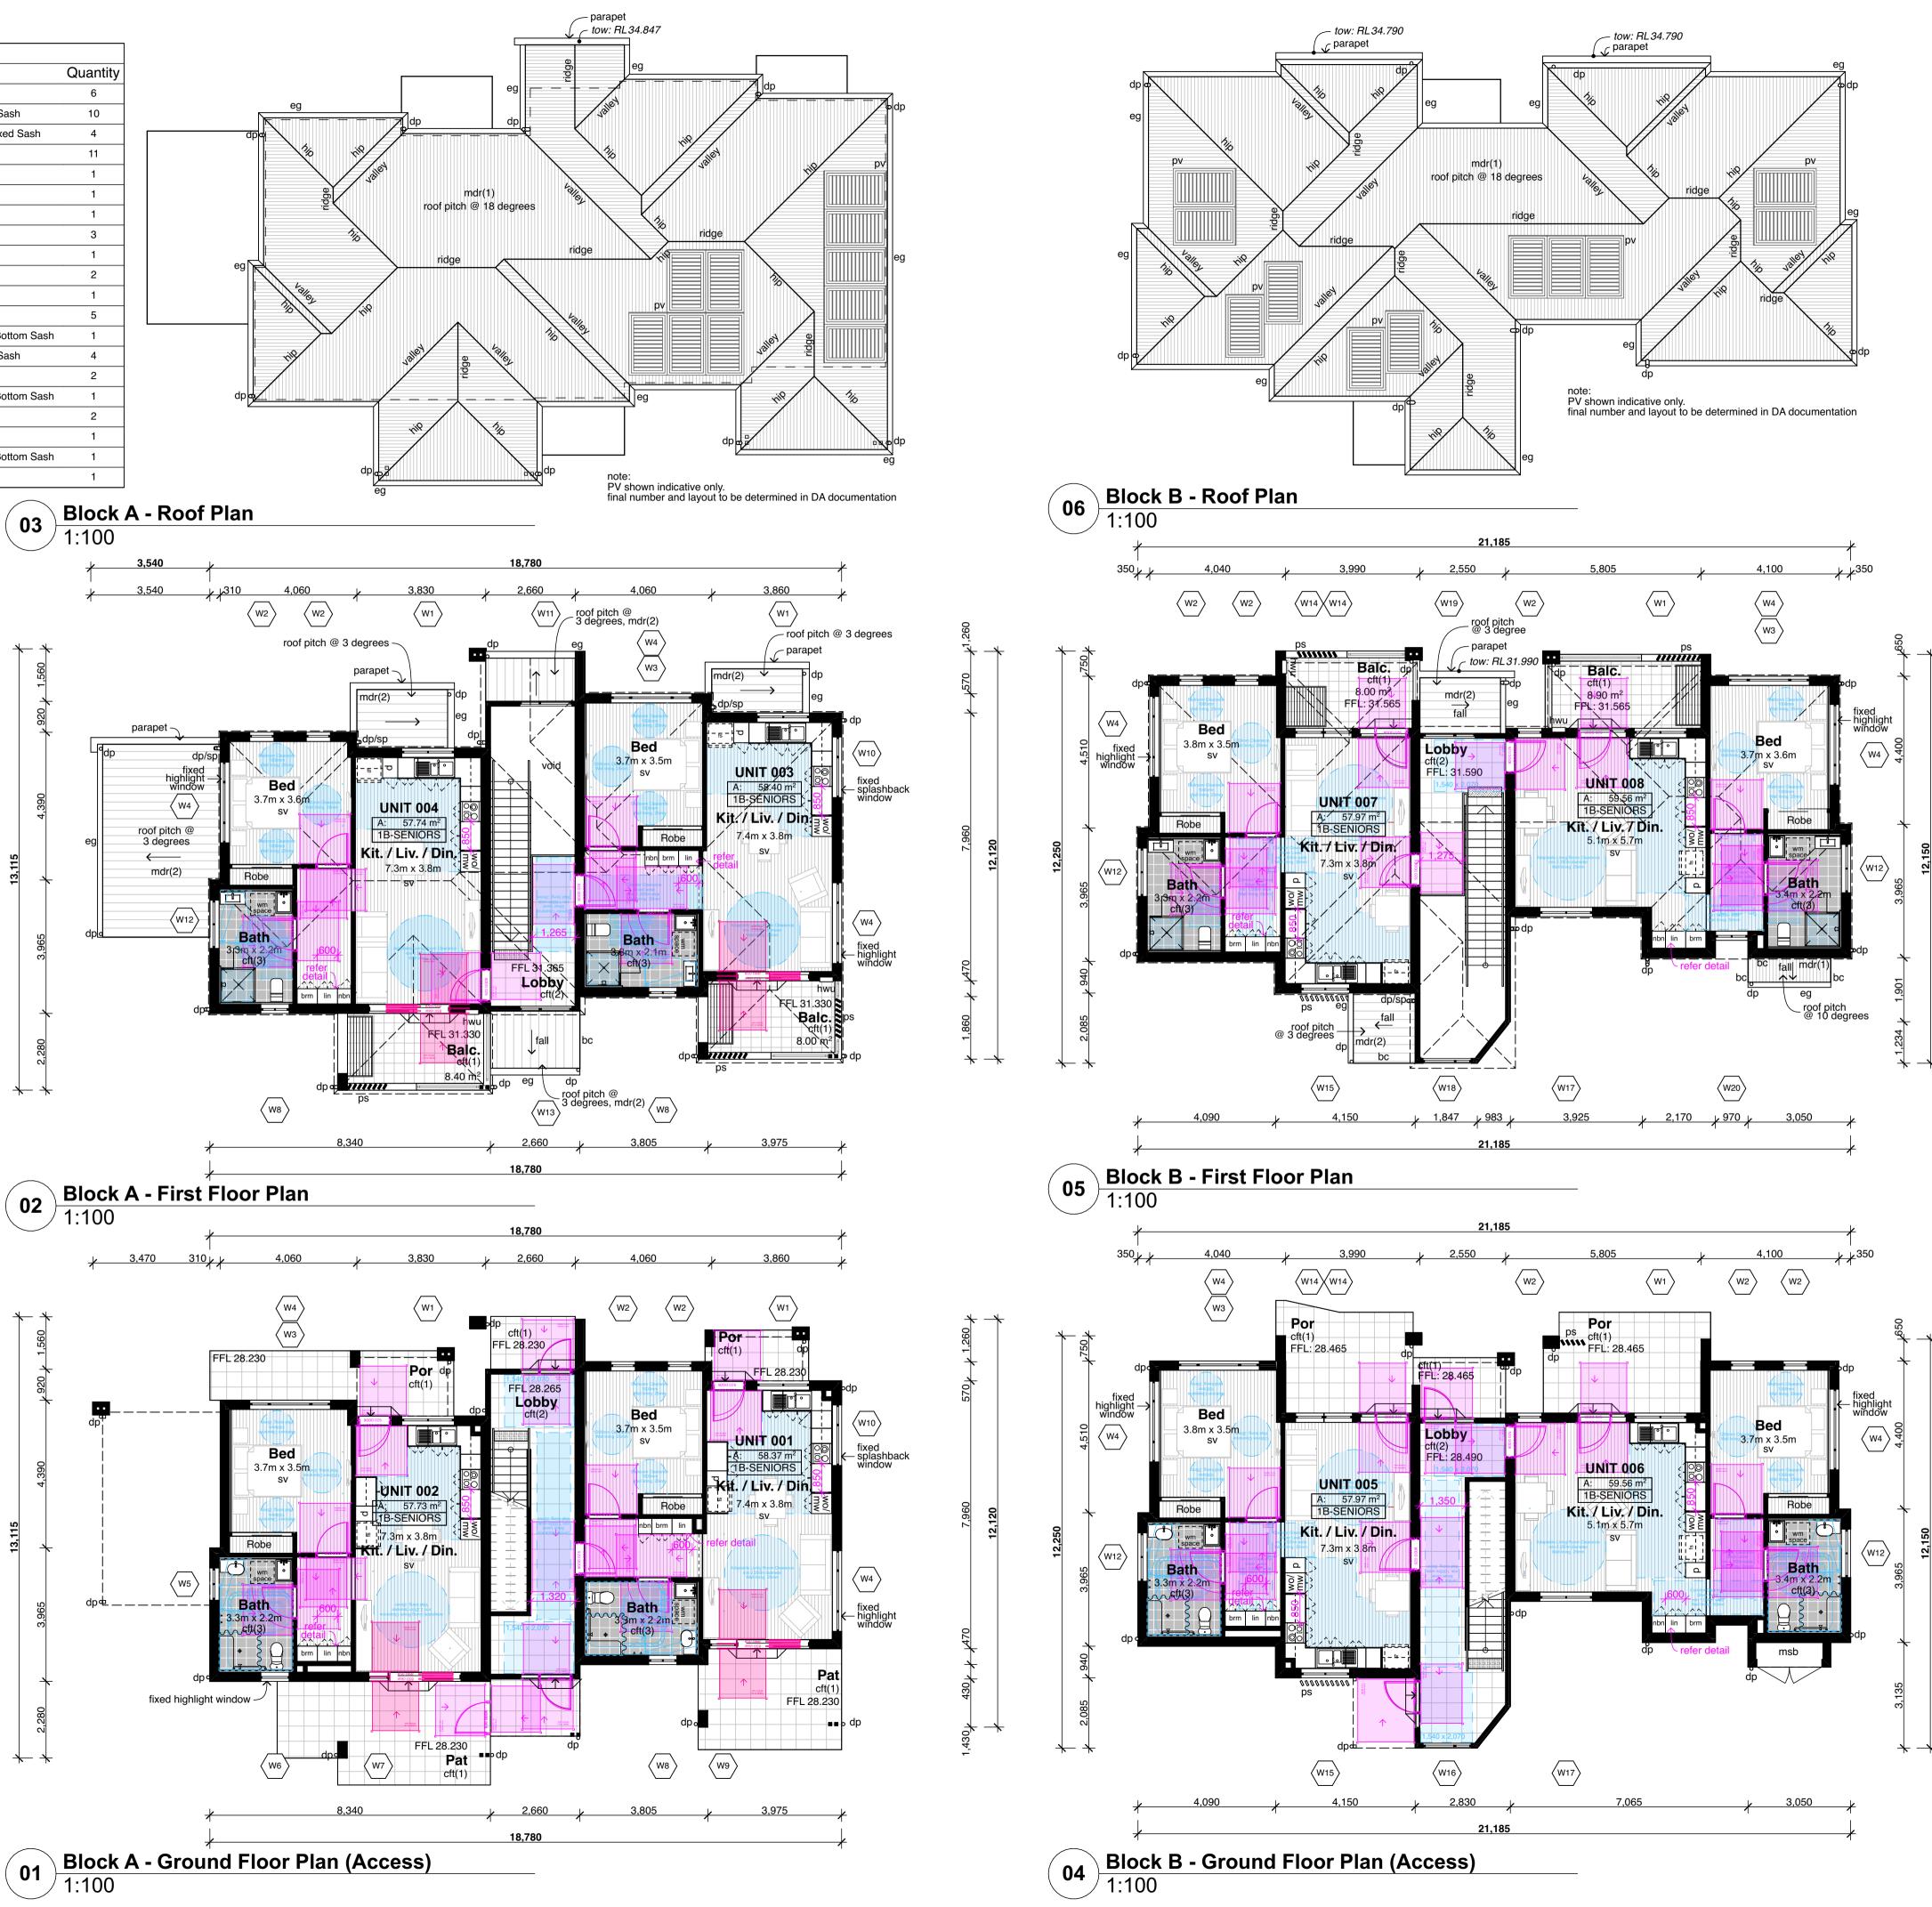

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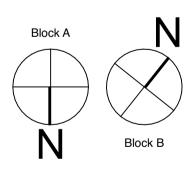
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# LAHC

Seniors living Development (x8 Units) 15-17 Combles Pde & 2-4 Hamel Rd, Matraville, NSW Drawn; CP Checked; AT Plot date; 23/10/23 Scale;1:100 as noted @ AI

Project No; 2701.21


Drawing No;

DA10

LAHC Project No; BGXPR

Revision#; DA2

Floor & Roof Plans

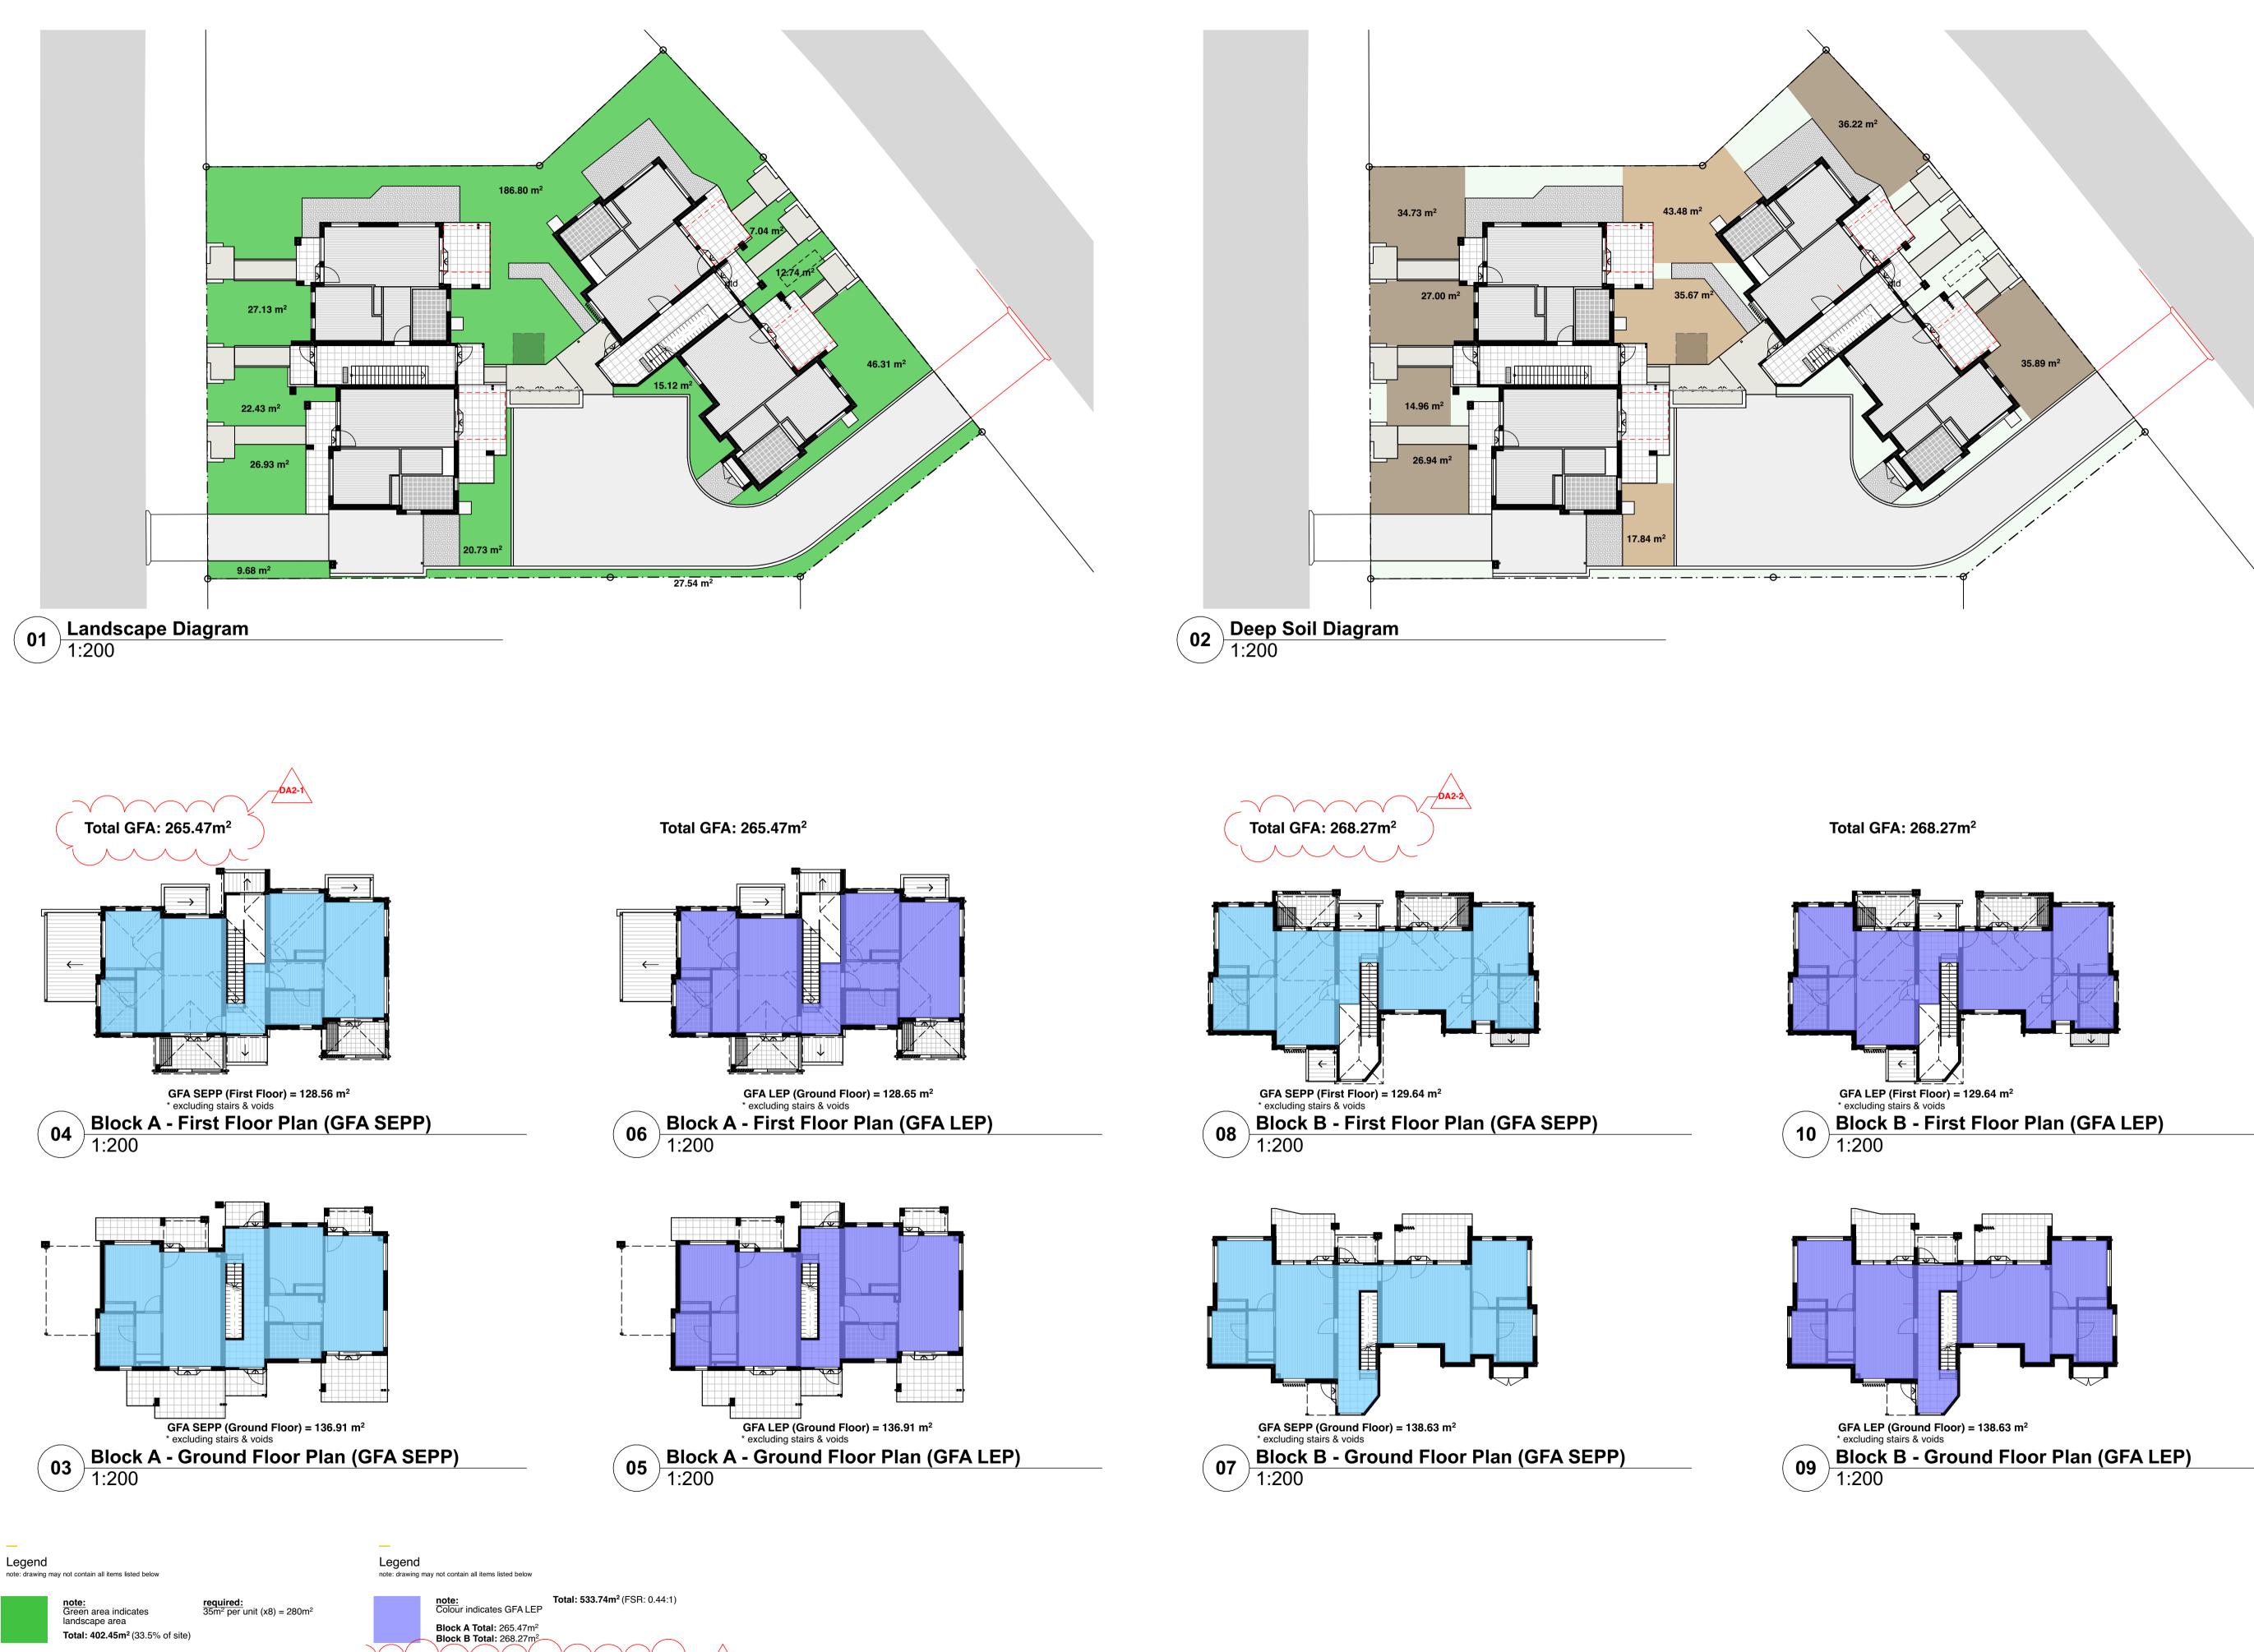

note: Brown area indicates deep soil zone (min. dim 3x3m) required: 15% of site = 180.21m<sup>2</sup> Total: 272.73m<sup>2</sup> (22.7% of site) mid block % = 96.99m2 (35.5% of total) asked for by previous planner

Total: 533.74m<sup>2</sup> (FSR: 0.44:1) Colour indicates GFA Housing SEPP 2021 Block A Total: 265.47m<sup>2</sup> Block B Total: 268.27m<sup>2</sup> Total: 533.74m<sup>2</sup> (FSR: 0.44:1)

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Seniors living Development (x8 Units) 15-17 Combles Pde & 2-4 Hamel Rd, Matraville, NSW

Drawn; CP Checked; AT Plot date; 23/10/23 Scale;1:200 as noted @ AI

Project No; 2701.21

Drawing No;

DA11

LAHC Project No; BGXPR

Revision#; DA2

Landscape, Deep Soil & GFA Diagrams



Face Brick (fb) PGH Bricks Range: Coastal Hamptons Colour: Gull Grey

\_

Feature Stone PGH Stone Range: Ledgestone Colour: Southwest Blend

Metal Roof mdr(1) Colorbond 'custom orb' Colorbond Shale Grey

**Metal Roof mdr(2)** Colorbond 'klip lok' Colorbond Shale Grey

| note: drawi | ng may not contain all items listed below | conc. | concrete               | gl    | ground line           | pap(1) | perforated acoustic panel (type) | sk      | skylight/skytube                                    |
|-------------|---|-------|------------------------|-------|-----------------------|--------|----------------------------------|---------|---|
| ac          | air conditioner condenser                 | CS    | coved skirting         | gt    | gate                  | pbd    | plasterboard                     | sl      | sliding door  |
| ag          | ag pipe                                   | dp    | downpipe               | hr(1) | handrail (type)       | ps     | privacy screen                   | ss(1)   | sun shade (type)                                    |
| ιlw         | aluminium framed window                   | drh   | door head              | hwu   | hot water unit        | pv     | photovoltaic cells               | ts      | timber skirting                                     |
| oal(1)      | balustrade (type)                         | eg    | eaves gutter           | ip    | insulated panel       | rc     | rendered concrete                | wcs     | window casing                                       |
| С           | barge capping                             | egl   | existing ground line   | lv(f) | fixed louvres         | rms    | raked metal soffit               | note:   |   |
| og          | box gutter                                | ex.   | existing               | lv(o) | operable louvres      | rp(1)  | render & paint finish (type)     |         | ndrails, balustrades &                              |
| ohc         | brick header course                       | f     | fixed sash window      | mc(1) | metal cladding (type) | rs     | roller shutter                   |         | atively only. refer to de<br>to engineer's drawings |
| ooe         | brick on edge                             | fb(1) | face brickwork (type)  | mdr   | metal deck roof       | rw     | retaining wall                   | 3. acou | stic pănel edges at all                             |
| bws         | brickwork sill                            | fcl   | finished ceiling level | ofc   | off form concrete     | rwh    | rainwater head                   |         | posed edges including                               |
| cfc         | compessed fibre cement                    | ffl   | finished floor level   | olv   | operable louvres      | S      | sliding sash window              |         | m (adjoining skirting) a<br>inium angle.            |
| cj          | control joint                             | fp    | feature panel          | p(1)  | paint (type)          | SC     | steel column                     |         | 5 5 5   |

CFC + Paint cfc(1) Dulux White

**CFC - cfc(2)** Barestone - Original

**CFC - cfc(3)** Barestone - Ash

**CFC - cfc(4)** Barestone - Graphite





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# LAHC

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Project No; 2701.21

Drawing No;

DA12

LAHC Project No; BGXPR

Revision#; DA2

Elevations (Block A)

#### **Columns**, **Downpipes**

Window & Door Frames, Fences, Fascias & Gutters - powdercoated Dulux Shale Grey

Entry Doors, Columns & Fence Infills Wood Look



bg bhc boe bws compessed fibre cement cfc control joint ci

finished floor level feature panel

fp

operable louvres p(1) paint (type)

SC

sliding sash window

steel column





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- full height privacy screen

- full height privacy screen

1,800mm high fence behind ft(3) refer SK19

1,800mm high fence behind ft(3) refer SK19

Entry Doors, Columns & Fence Infills Wood Look







# LAHC

Seniors living Development (x8 Units) 15-17 Combles Pde & 2-4 Hamel Rd, Matraville, NSW

Drawn; CP Checked; AT Plot date; 23/10/23 Scale;1:100, 1:4.960 as noted @ AI

Project No; 2701.21 LAHC Project No; BGXPR

Drawing No; DA13

Revision#; DA2

Elevations (Block B)



**02** Section (Block B) 1:100

| Legen  | d (elevation & sections)                  |       |                        |       |                       |        |                                  |                        |   |
|--------|---|-------|------------------------|-------|-----------------------|--------|----------------------------------|------------------------|---|
| •      | ng may not contain all items listed below | conc. | concrete               | gl    | ground line           | pap(1) | perforated acoustic panel (type) | sk                     | skylight/skytube                                    |
| ac     | air conditioner condenser                 | CS    | coved skirting         | gt    | gate                  | pbd    | plasterboard                     | sl                     | sliding door  |
| ag     | ag pipe                                   | dp    | downpipe               | hr(1) | handrail (type)       | ps     | privacy screen                   | ss(1)                  | sun shade (type)                                    |
| alw    | aluminium framed window                   | drh   | door head              | hwu   | hot water unit        | pv     | photovoltaic cells               | ts                     | timber skirting                                     |
| bal(1) | balustrade (type)                         | eg    | eaves gutter           | ip    | insulated panel       | rc     | rendered concrete                | wcs                    | window casing                                       |
| bc     | barge capping                             | egl   | existing ground line   | l∨(f) | fixed louvres         | rms    | raked metal soffit               | note:                  |   |
| bg     | box gutter                                | ex.   | existing               | lv(o) | operable louvres      | rp(1)  | render & paint finish (type)     |                        | andrails, balustrades &                             |
| bhc    | brick header course                       | f     | fixed sash window      | mc(1) | metal cladding (type) | rs     | roller shutter                   |                        | atively only. refer to de<br>to engineer's drawings |
| boe    | brick on edge                             | fb(1) | face brickwork (type)  | mdr   | metal deck roof       | rw     | retaining wall                   | <ol><li>acou</li></ol> | stic panel edges at all                             |
| bws    | brickwork sill                            | fcl   | finished ceiling level | ofc   | off form concrete     | rwh    | rainwater head                   |                        | posed edges including<br>m (adjoining skirting) a   |
| cfc    | compessed fibre cement                    | ffl   | finished floor level   | olv   | operable louvres      | S      | sliding sash window              |                        | inium angle.  |
| cj     | control joint                             | fp    | feature panel          | p(1)  | paint (type)          | SC     | steel column                     |                        | 5   |

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| DA2  | Part 5 Issue       | 25/10/23 |
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# LAHC

Seniors living Development (x8 Units) 15-17 Combles Pde & 2-4 Hamel Rd, Matraville, NSW Drawn; CP

Drawn; CP Checked; AT Plot date; 23/10/23 Scale;1:100 as noted @ AI

Project No; **2701.21** 

Drawing No;

DA14

LAHC Project No; BGXPR


Revision#; DA2

Sections


Solar Access Unit 1 Living = 7hrs Unit 1 POS = 4hrs Unit 3 Living = 6hrs Unit 3 POS = 7hrs




Shadow Perspective Units 1 & 3 (12pm June 21) 04 <sup>/</sup> not to scale

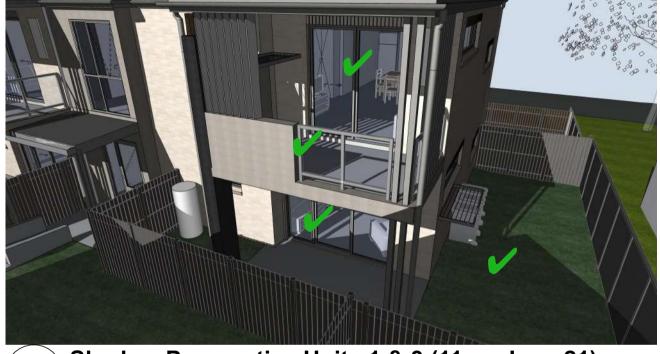



Shadow Perspective Units 1 & 3 (11am June 21) 03 not to scale

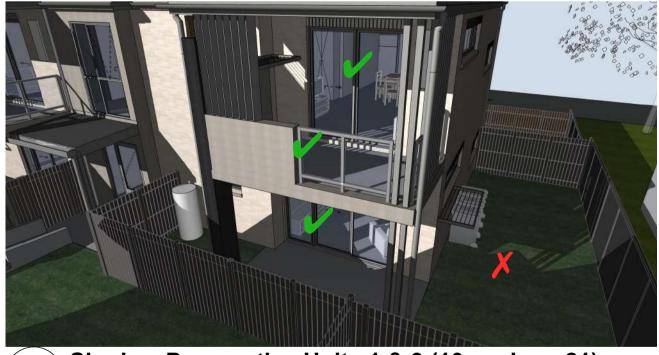

Shadow Perspective Units 1 & 3 (10am June 21) 02 not to scale

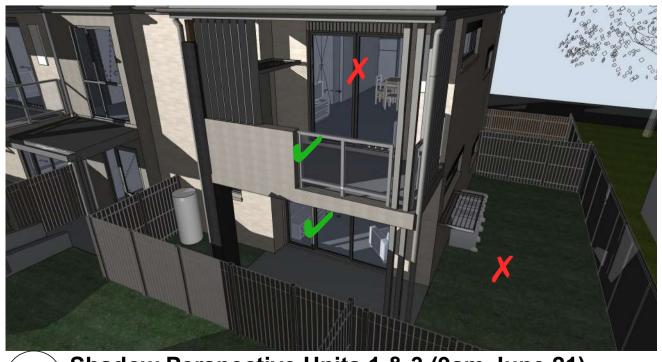

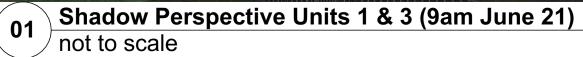


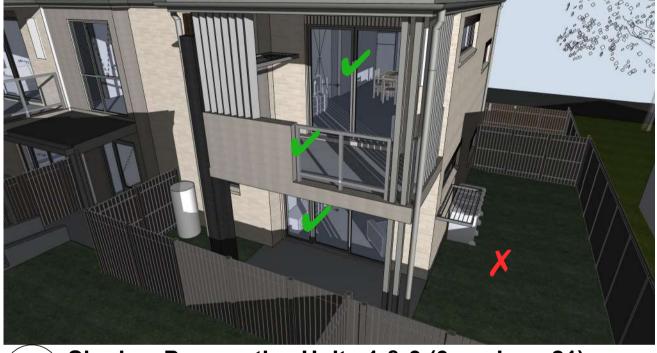

Shadow Perspective Units 1 & 3 (3pm June 21) 07 not to scale



Shadow Perspective Units 1 & 3 (2pm June 21) 06 not to scale

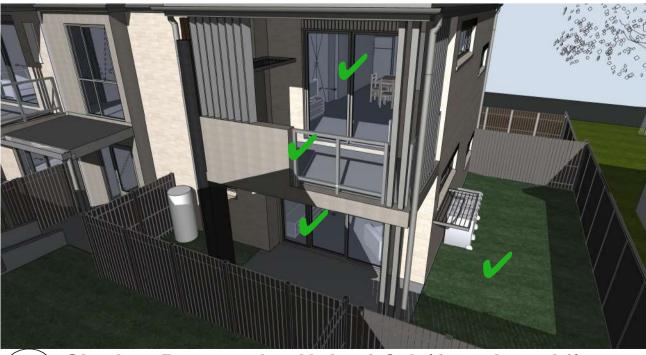

05 Shadow Perspective Units 1 & 3 (1pm June 21) / not to scale

Solar Access Unit 2 Living = 6hrs Unit 2 POS = 4hrs Unit 4 Living = 4hrs Unit 4 POS = 6hrs



Shadow Perspective Units 2 & 4 (12pm June 21) <sup>/</sup> not to scale



Shadow Perspective Units 2 & 4 (11am June 21) 10 not to scale



Shadow Perspective Units 2 & 4 (10am June 21) 09 not to scale



Shadow Perspective Units 2 & 4 (9am June 21) 08 / not to scale



14 not to scale



13 not to scale



12 not to scale

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| DA2  | Part 5 Issue       | 25/10/23 |

Shadow Perspective Units 2 & 4 (3pm June 21)







# LAHC

Seniors living Development (x8 Units) 15-17 Combles Pde & 2-4 Hamel Rd, Matraville, NSW Drawn; CP Checked; AT Plot date; 23/10/23

Scale;1:420.185 as noted @ AI

Project No; 2701.21

DA15

LAHC Project No; BGXPR

Drawing No;

Revision#; DA2

Shadow Analysis (Sht 1)

Solar Access Unit 5 Living = 3hrs Unit 5 POS = 7hrs Unit 7 Living = 5hrs Unit 7 POS = 6hrs



Shadow Perspective Units 5 & 7 (12pm June 21) 04 not to scale



Shadow Perspective Units 5 & 7 (11am June 21) 03 not to scale



Shadow Perspective Units 5 & 7 (10am June 21) 02 not to scale







07 not to scale



**〔06**〕 not to scale



05 <sup>/</sup> not to scale

Solar Access Unit 6 Living = 4hrs Unit 6 POS = 7hrs Unit 8 Living = 4hrs Unit 8 POS = 5hrs



Shadow Perspective Units 6 & 8 (12pm June 21) <sup>/</sup> not to scale



Shadow Perspective Units 6 & 8 (11am June 21) 10 not to scale



Shadow Perspective Units 6 & 8 (10am June 21) 09 not to scale



08 Shadow Perspective Units 6 & 8 (9am June 21) / not to scale



14 not to scale



13 not to scale



12 not to scale

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|      |                    |          |

Shadow Perspective Units 6 & 8 (3pm June 21)







# LAHC

Seniors living Development (x8 Units) 15-17 Combles Pde & 2-4 Hamel Rd, Matraville, NSW Drawn; CP

Checked; AT Plot date; 23/10/23 Scale;1:420.185 as noted @ AI

Project No; 2701.21 LAHC Project No; BGXPR

Drawing No; DA16

Revision#; DA2

Shadow Analysis (Sht 2)



08 Shadow Perspective (6 Hamel Rd) (3pm June 21) not to scale



03 Shadow Perspective (6 Hamel Rd) (2pm June 21) not to scale




02 Shadow Perspective (6 Hamel Rd) (1pm June 21) not to scale



01 Shadow Perspective (6 Hamel Rd) (12pm June 21) not to scale





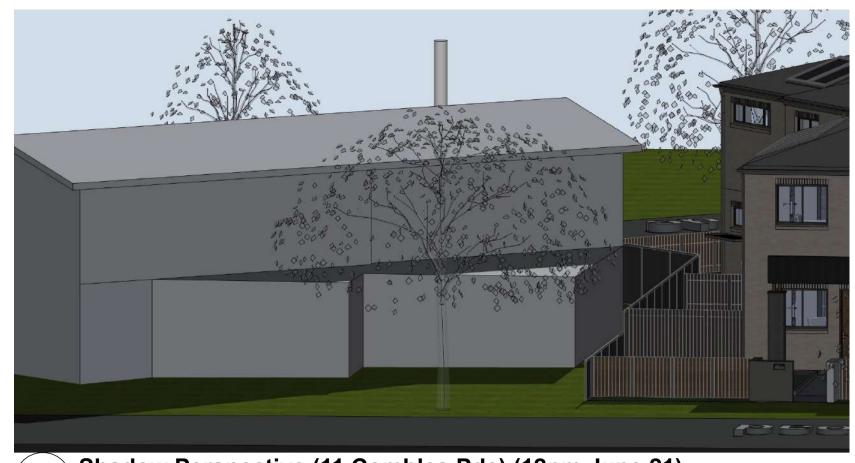

07 Shadow Perspective (11 Combles Pde) (12pm June 21) not to scale



06 Shadow Perspective (11 Combles Pde) (11am June 21) not to scale



05 Shadow Perspective (11 Combles Pde) (10am June 21) not to scale



04 Shadow Perspective (11 Combles Pde) (9am June 21) not to scale

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| Rev  | Issue              | Date     |
|------|--------------------|----------|
| DAP1 | Draft Part 5 Issue | 19/09/23 |
| DA1  | Part 5 Issue       | 28/09/23 |
| DA2  | Part 5 Issue       | 25/10/23 |
|      |                    |          |







# LAHC

Seniors living Development (x8 Units) 15-17 Combles Pde & 2-4 Hamel Rd, Matraville, NSW

Drawn; CP Checked; AT Plot date; 23/10/23 Scale;1:327.744 as noted @ AI

Project No; **2701.21** 


Drawing No;

DA17

LAHC Project No; BGXPR

Revision#; DA2

Shadow Analysis (Sht 3)

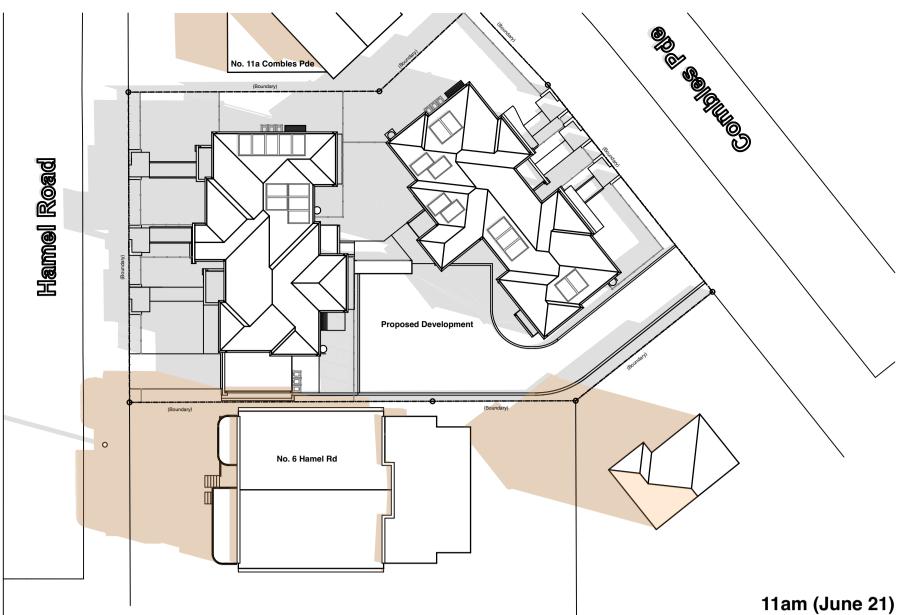

б

80 80

<u>l</u>


Ц В


9

Hai

Hamel Road

(Boundary)

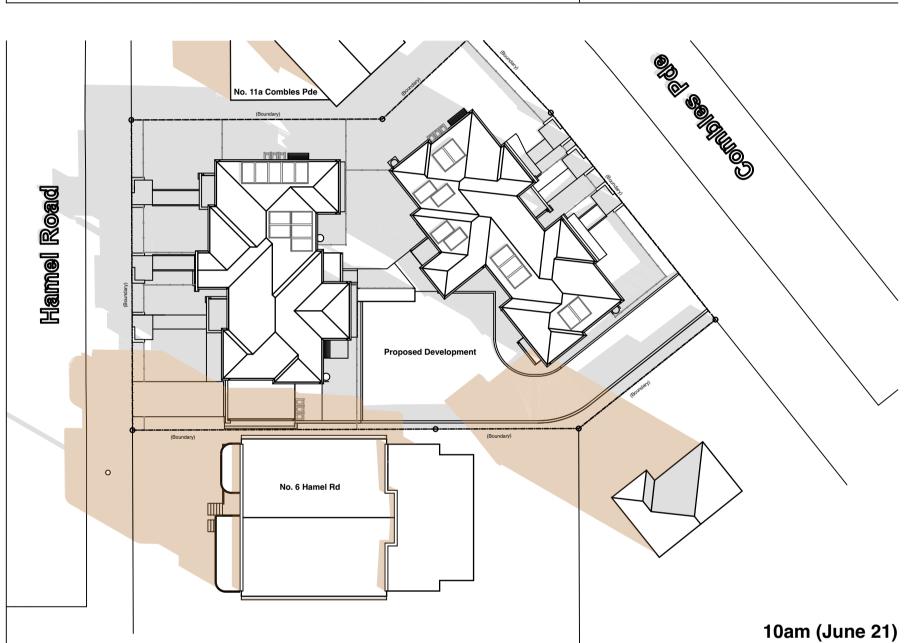


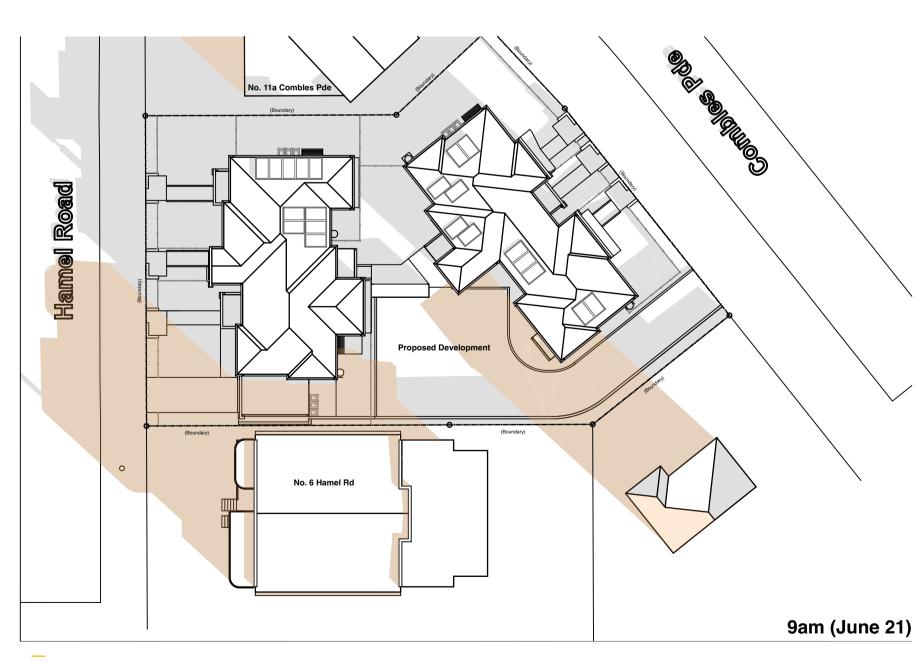



Legend shadow diagrams note: drawing may not contain all items listed below

> **note:** shadows cast: existing neighbour buildings

note: shadows cast: proposed buildings

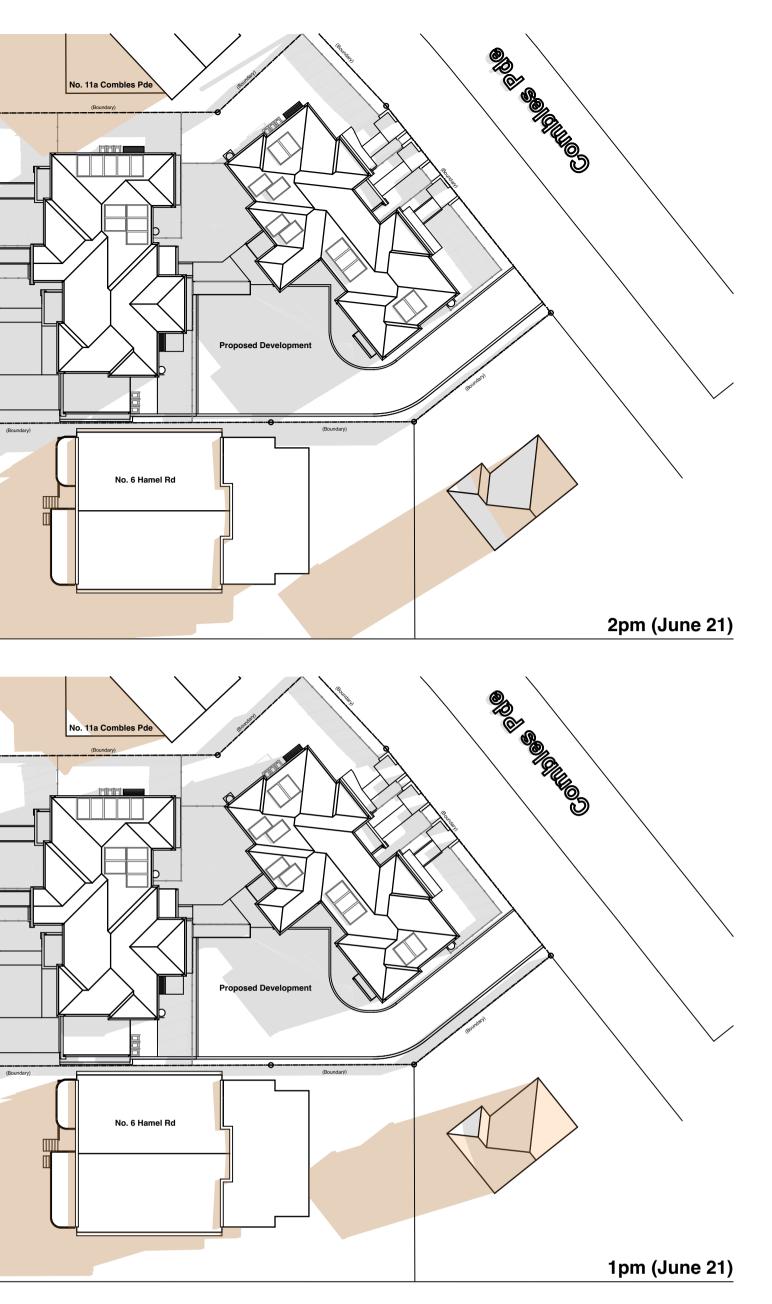

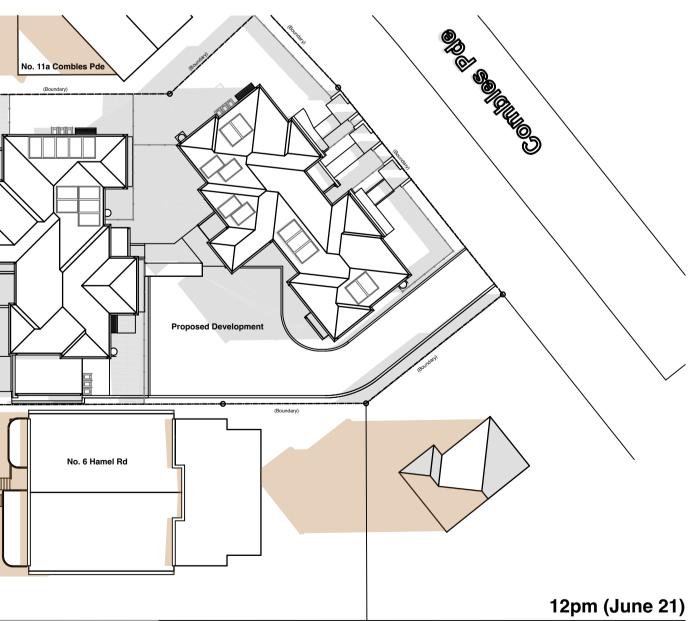

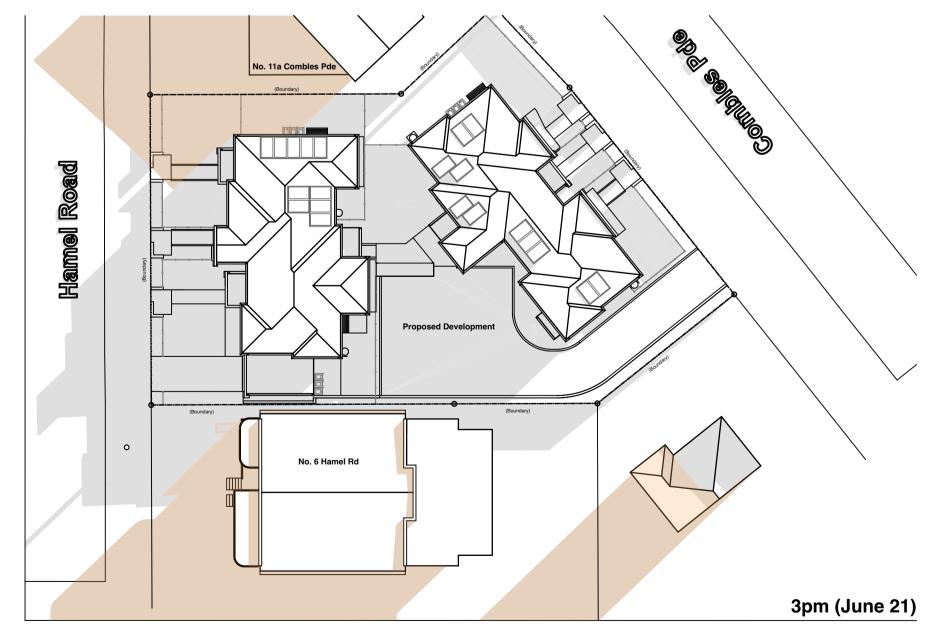

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| Rev  | Issue              | Date     |
|------|--------------------|----------|
| DAP1 | Draft Part 5 Issue | 19/09/23 |
| DA1  | Part 5 Issue       | 28/09/23 |
| DA2  | Part 5 Issue       | 25/10/23 |
|      |                    |          |









# LAHC

Seniors living Development (x8 Units) 15-17 Combles Pde & 2-4 Hamel Rd, Matraville, NSW Drawn; CP

Drawn; CP Checked; AT Plot date; 23/10/23 Scale;1:323.179 as noted @ AI

Project No; **2701.21** 

Drawing No;

DA18


LAHC Project No; BGXPR

Revision#; DA2

Shadow Analysis (Sht 4)





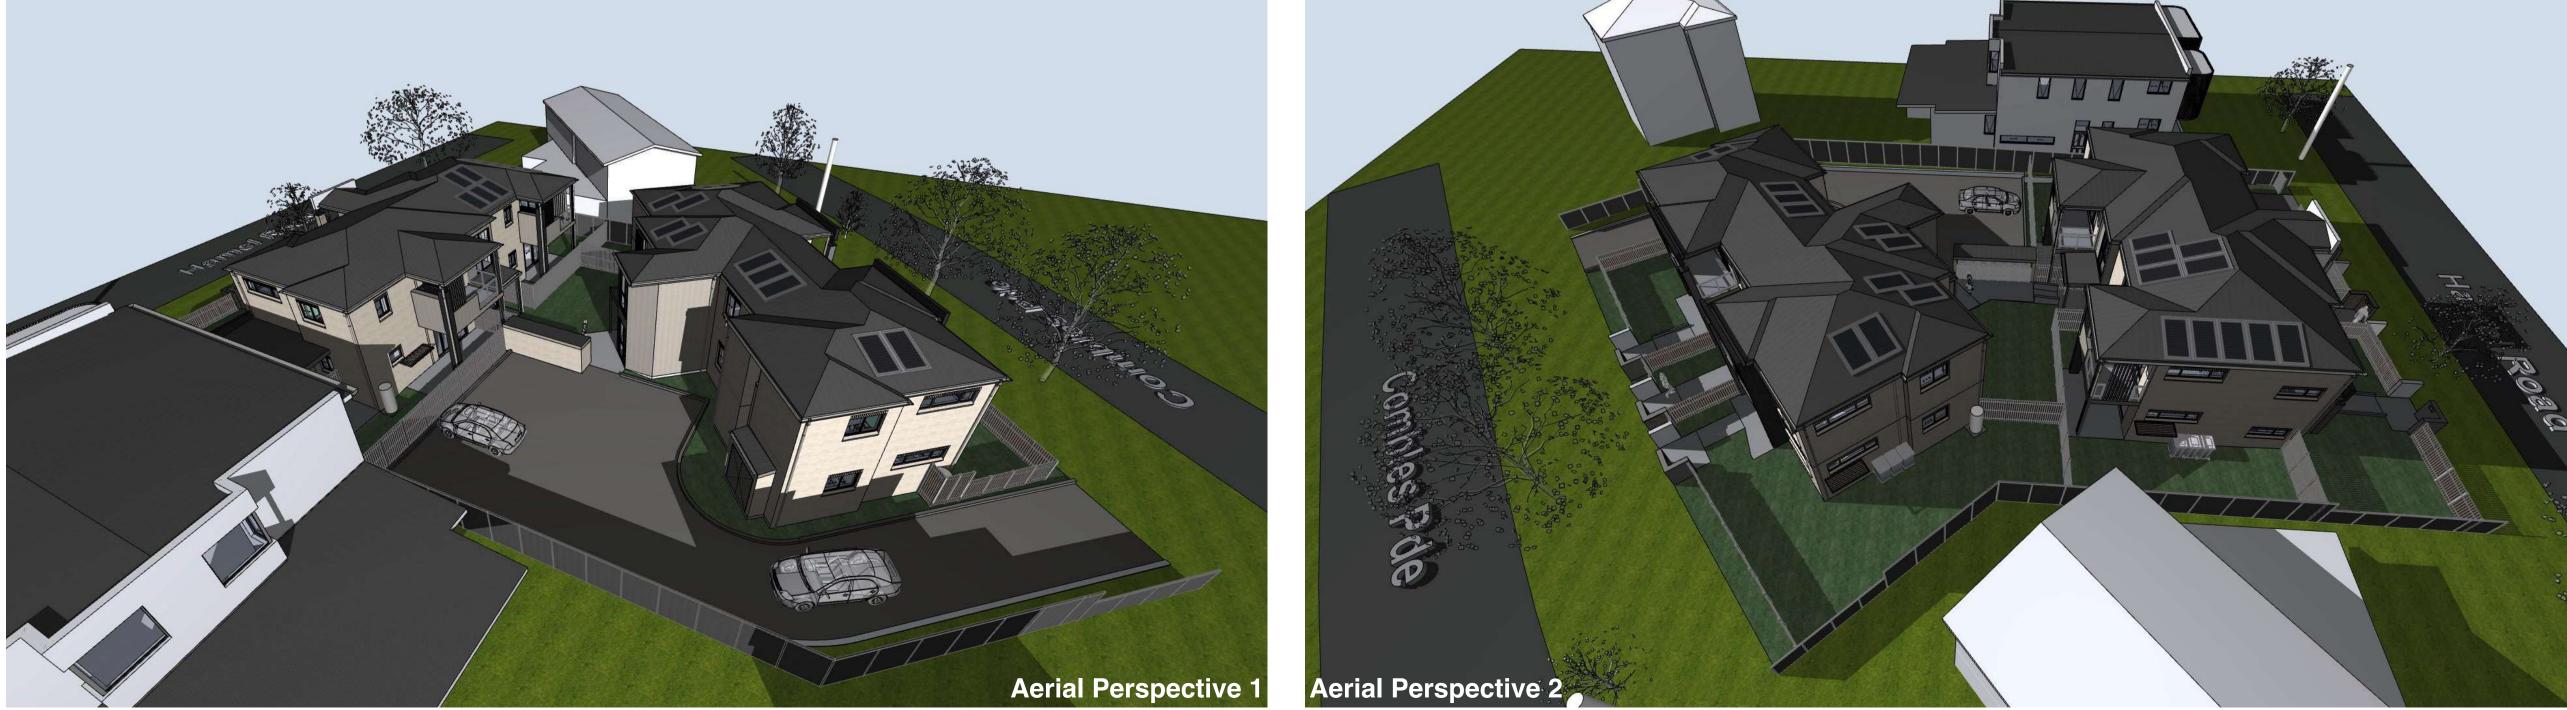

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| Rev  | Issue              | Date     |
|------|--------------------|----------|
| DAP1 | Draft Part 5 Issue | 19/09/23 |
| DA1  | Part 5 Issue       | 28/09/23 |
| DA2  | Part 5 Issue       | 25/10/23 |







# LAHC

Seniors living Development (x8 Units)
15-17 Combles Pde & 2-4 Hamel Rd,
Matraville, NSW
Drawn; CP
Checked; AT
Plot date; 23/10/23

Scale; as noted @ AI

Project No; **2701.21** 


Drawing No;


DA19

LAHC Project No; BGXPR

Revision#; DA2

**3D** Perspectives

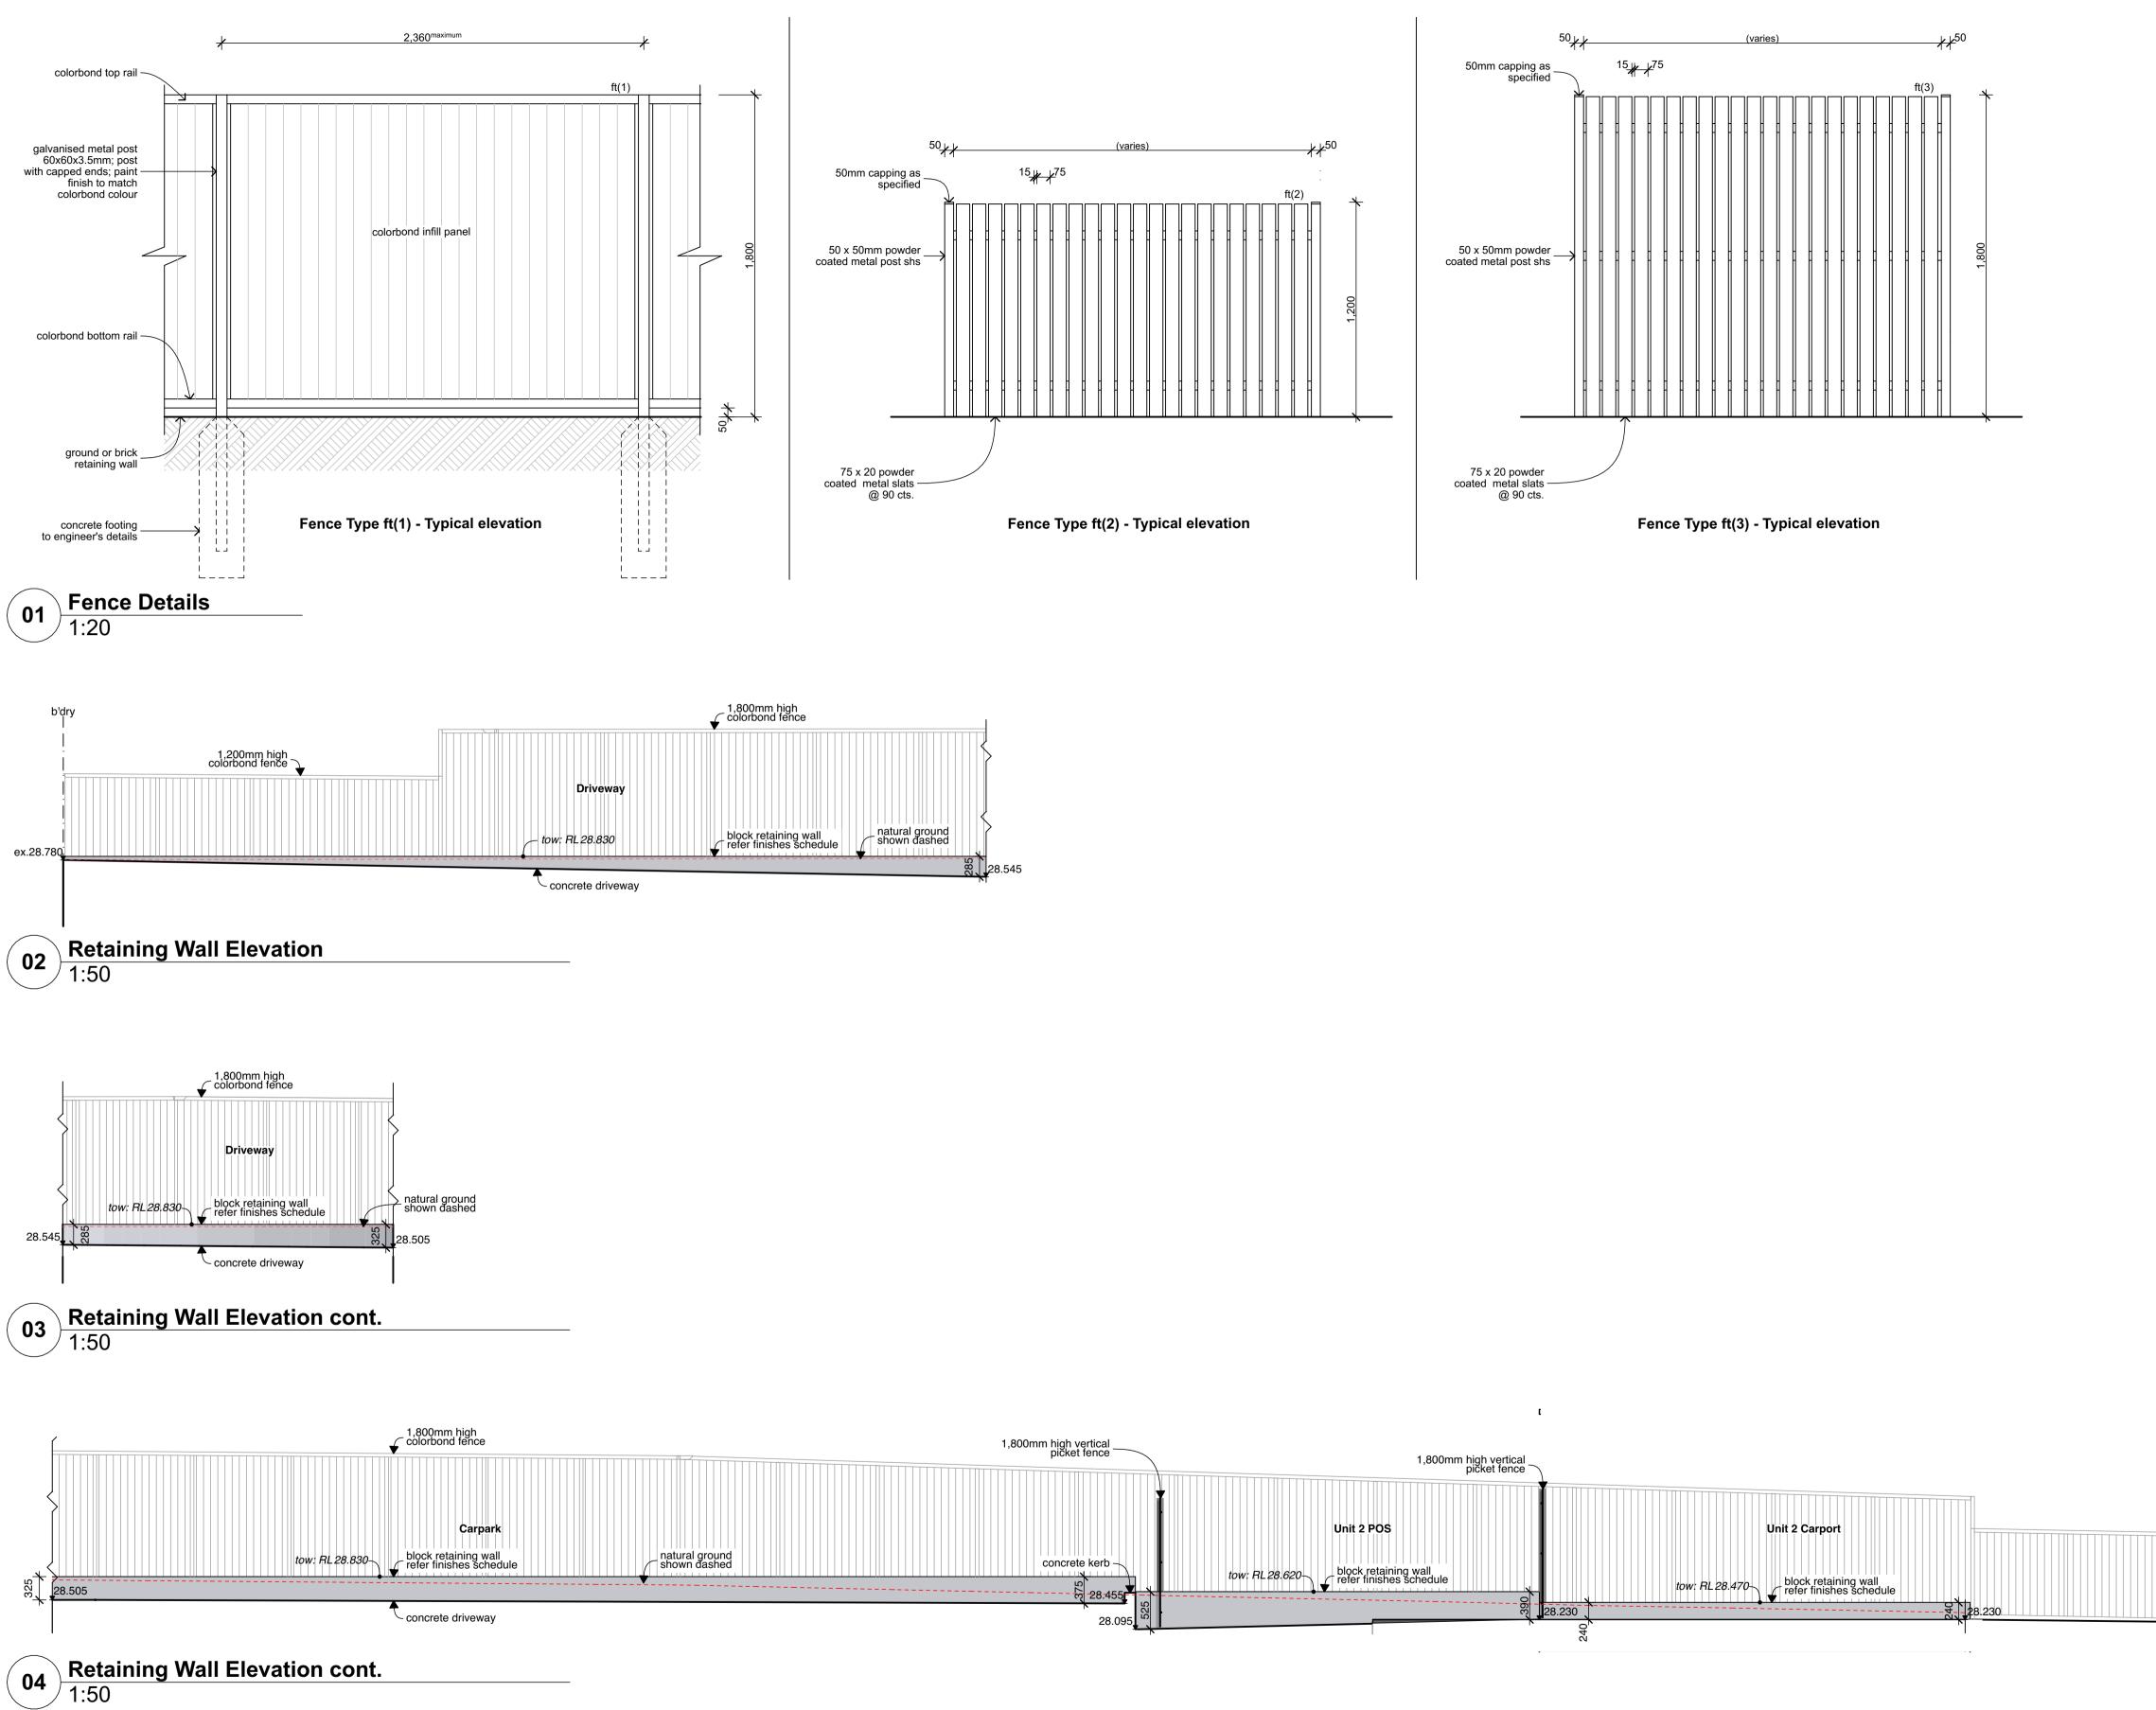

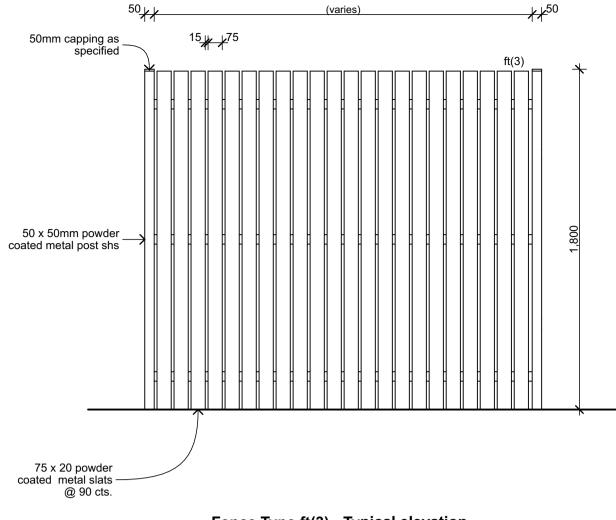

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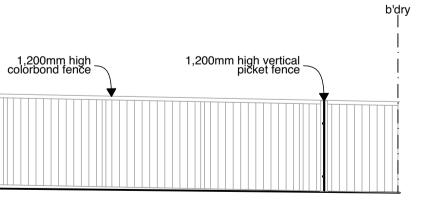
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| Rev  | Issue              | Date     |
|------|--------------------|----------|
| DAP1 | Draft Part 5 Issue | 19/09/23 |
| DA1  | Part 5 Issue       | 28/09/23 |
| DA2  | Part 5 Issue       | 25/10/23 |
|      |                    |          |









# LAHC

Seniors living Development (x8 Units) 15-17 Combles Pde & 2-4 Hamel Rd, Matraville, NSW Drawn; CP Checked; AT Plot date; 23/10/23

Scale;1:20, 1:50 as noted @ AI

Project No; 2701.21

Drawing No;

DA20

LAHC Project No; BGXPR

Revision#; DA2

Fence & Retaining Wall Details